ABBREVIATIONS JOIST JOINT ACS FLR ACCESS FLOOR (ING) LONG; LENGTH LABORATORY I AMINATE (D LAVATORY ADDM POUNDS **ADDENDUM ABOVE FINISH COUNTER** LINEAR FEET **ALTERNATE** AMERICAN NATIONAL STANDARDS **APPROXIMATE** MAXIMUM APPROX MARKER BOARD MDF AMERICAN SOCIETY FOR TESTING MFDIUM METAL AND MATERIALS MANUFACTURE MINIMUM; MINUTE **MISCELLANEOUS** BITUMINOUS MASONRY OPENING: MOTOR BLDG OPERATED BLOCKING MOUNTING BRIDGING **BOTH SIDES** NOT IN CONTRACT NOMINAL NOT TO SCALE CAP CAPACITY CH BD CHALKBOARD **OUTSIDE DIAMETEI** CONTROL JOINT CLG OPPOSITE CLO **OVERHEAD** CASED OPENING PLATE PLASTIC LAMINATE COL CONC **PLASTER** CONCRETE CONN CONNECTION PLUMBING PLYWOOD CONT CONTR CONTRACTOR PAINTED COORD PARTITION POLYVINYL CHLORIDE CU RADIUS: RISER ROOF DRAIN REINFORCEMEN[®] DET DETAIL RESILIEN1 DF DRINKING FOLINTAL REVISION ROOM ROUGH OPENING ROOF TOP UNIT DOOR DOWNSPOU^T SOUTH SUSPENDED ACOUSTICAL PANEL **EAST** EACH SUSPENDED ACOUSTICAL TILE EACH END CFII ING **EACH FACE** SCHED SCHEDULE (D) SOLID CORE WOOD **EXPANSION JOINT ELEVATION** SECT SECTION STOREFRONT; SQUARE FOOT ELECTRIC (AL) ELEV ELEVATOR SIMII AR **EMER EMERGENCY** SQUARE ENCL **ENCLOSE (URE)** STAINLESS STEEL ETHYLENE PROPYLENE DIENE STREET SOUND TRANSMISSION CRITERIA MONOMER STD **EQUAL** STANDARD FQUIP FOUIPMENT STFFI STORAGE ELECTRIC WATER COOLER STRUCT STRUCTURE (AL) **EXHAUST** SUSPENDED SYMM SYMMETRY (ICAL) EXIST **EXISTING** EXP EXPOSED; EXPANSION EXTERIOR; EXTINGUISHER TONGUE AND GROOVE FAHRENHEI1 T/O TOP OF F/O FACE OF TELEPHONE FIRE ALARM TEMPERATURE; TEMPORARY THICK (NESS) FLOOR DRAIN FDTN FOUNDATION THRU THROUGH TK BD TACK BOARD FIRE EXTINGUISHER TOP OF WALL FIRE HYDRANT TOW FIN FINISH (ED) TRTD TREATED FLASH **TELEVISION** FLASHING FLR FLOOR **TYPICAL** FLUOR FLUORESCENT FIRE RESISTANT UNDER COUNTER FRTW FIRE RETARDANT TREATED WOOD UGND UNDERGROUND FOOT, FFF1 UNDERWRITER'S LABORATORIES UNLESS OTHERWISE NOTED FLUE THRU ROOF **FURG** VCT VINYL COMPOSITION TILE FURRING (ED) VERTICAL GALV VENT THRU ROOF GALVANIZED GLASS VINYL WALL COVERING GYP GYPSUM WIDTH; WASTE; WEST; WIRE HOSE BIBB WITH WITHOUT **HANDICAP** W/O HOLLOW CORE WOOD WATER CLOSET HDW HARDWARE WOOD HOLLOW METAL WINDOW HORIZ HORIZONTAL WATERPROOF (ING); WORK POINT HPT WELDED WIRE REINFORCING HEATING/VENTILATING/AIR HVAC XFMR TRANSFORMER CONDITIONING HOT WATER INSIDE DIAMETER INCLUDE (D), (ING) INFORMATION

CONTACTS

VDOT RICHMOND DISTRICT FACILITIES MANAGER: JOSH ANDELIN; 757-561-4509

ARCHITECT / ENGINEER

GAUTHIER, ALVARADO AND ASSOCIATES STEPHANIE STEIN; 703-241-2202

VIRGINIA DEPARTMENT OF TRANSPORTATION PETERSBURG & SOUTH HILL, VA

State Project No. 501-B2501-012

PETERSBURG & SOUTH HILL RESIDENCY RESTROOM RENOVATIONS

PERMIT SET

12-12-2022

GENERAL NOTES

- PERFORM WORK IN ACCORDANCE WITH APPLICABLE FEDERAL, AND STATE GOVERNING ORDINANCES, CODES AND REGULATIONS

- PROVIDE FRAMED SUPPORT FOR ALL DUCTS AND MECHANICAL EQUIPMENT AS REQUIRED FOR COMPLETE SUPPORT AT 2-1/2 TIMES LOAD
- MAINTAIN THE INTEGRITY OF ALL EXISTING FIRE RATED ASSEMBLIES

ASSOCIATES

ARCHITECTURE | ENGINEERING | PLANNING 10201 FAIRFAX BOULEVARD, SUITE 225, FAIRFAX, VIRGINIA 703-241-2202 WWW.GAA-AE.COM

STATEMENTS

ASBESTOS STATEMENT: BUILDING #4250004

APPENDIX A TO THE PROJECT SPECIFICATIONS. MATERIALS CONTAINING ASBESTOS BUT ARE NOT TO ACCESS ANY MATERIAL SUSPECTED OF CONTAINING ASBESTOS NOT IDENTIFIED BY THESE REPORTS, HE SHALL STOP WORK IN THE IMMEDIATE AREA AND NOTIFY THE OWNER (VDOT).

THE REMOVAL OF ASBESTOS MATERIALS IS NOT TO BE CONDUCTED WITHOUT THE OWNERS ASBESTOS PROJECT MONITOR BEING ON-SITE.

LEAD STATEMENT: BUILDING #4250004


AN INSPECTION TO IDENTIFY LEAD COATED BUILDING COMPONENTS HAS BEEN CONDUCTED AND CAN BE FOUND AS PART OF APPENDIX A TO THE PROJECT SPECIFICATIONS. THIS REPORT IS PROVIDED FOR THE CONTRACTOR'S USE AND MAY NOT BE ALL INCLUSIVE. IT IS THE CONTRACTOR'S RESPONSIBILITY TO COMPLY WITH ALL VIRGINIA OCCUPATIONAL SAFETY AND HEALTH (VOSH) REGULATIONS AS THEY PERTAIN TO EMPLOYEE EXPOSURES TO LEAD.


ALL LEAD AND LEAD COATED BUILDING COMPONENTS SHALL BE RECYCLED WHENEVER POSSIBLE

GAUTHIER, ALVARADO & ASSOCIATES ASSUMES NO RESPONSIBILITY FOR THE ADEQUACY OR ACCURACY OF THE ASBESTOS AND LEAD INSPECTION REPORTS CONTAINED IN THE CONTRACT DOCUMENTS AS THIS INFORMATION WAS PREPARED BY VDOT. THE CONTRACTOR SHALL ADDRESS ANY RELATED QUESTIONS TO THE VDOT REPRESENTATIVE.

SYMBOLS

PETERSBURG RESIDENCY MAPS

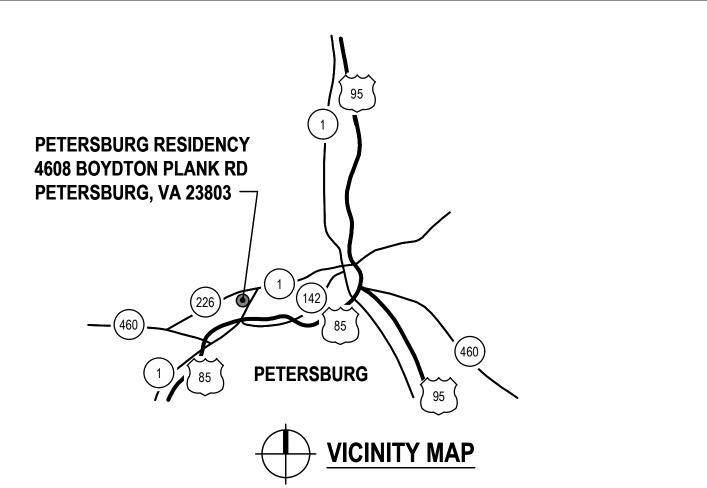

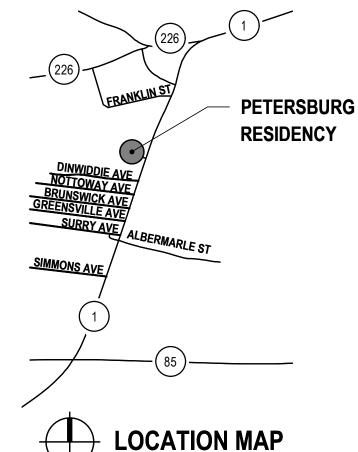

DESCRIPTION OF WORK

OF THE BUILDING.

RESTROOM RENOVATIONS TO PROVIDE ADA

HIGH PERFORMANCE BUILDING ACT

COMPLIANCE AND BABY CHANGING STATIONS WITH

ASSOCIATED FINISH, HVAC AND ELECTRICAL WORK.

IN ACCORDANCE WITH THE HIGH PERFORMANCE

RENOVATIONS DOES NOT EXCEED 50% OF THE VALUE

VIRGINIA ENERGY CONSERVATION CODE


CONSERVATION CODE (VECC), THE BUILDING SHALL

COMPLY WITH VECC SECTIONS C402 THROUGH C405

IN ACCORDANCE WITH THE VIRGINIA ENERGY

BUILDING ACT, THE BUILDING IS EXEMPT FROM

COMPLIANCE BECAUSE THE COST OF THE

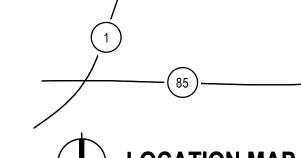

PETERSBURG RESIDENCY BUILDING DATA

LOBBY ROOM DESIGNATION - BUILDING SECTION LETTER ∼ ROOM NUMBER A101 A301 SHEET WHERE DRAWN - SHEET WHERE CUT - SECTION NUMBER REVISION NUMBER 1 DETAIL NUMBER - COLUMN DESIGNATION

MATERIALS

INSULATION ₩ EARTH (LARGE SCALE) (BATT OR LOOSE) INSULATION GRAVEL (SMALL SCALE) (RIGID) GYPSUM BOARD. CONCRETE CEMENT, GROUT

MASONRY UNIT

EXISTING BUILDING INFORMATION ORIGINAL BLDG CODE AND YEAR: UNKNOWN YEAR BUILT: USE GROUP OF BUILDING: B / A3 MIXED USE, NON-SEPARATED TYPE OF CONSTRUCTION: VΒ

NUMBER OF STORIES: HIGH RISE BUILDING: FIRST FLOOR AREA: 2,535 SF BASEMENT FLOOR AREA: 2,320 SF BUILDING TOTAL FLOOR AREA: 4,855 SF FIRST FLOOR OCCUPANT LOAD: 34 OCCUPANTS BASEMENT OCCUPANT LOAD: 58 OCCUPANTS TOTAL BUILDING OCCUPANT LOAD: 92 OCCUPANTS

EXISTING FIRE PROTECTION SYSTEM SPRINKLERS: APPROVED CENTRAL STATION: NO FIRE ALARM SYSTEM: STANDPIPES: **EXISTING FIRE RATING REQUIREMENTS**

BEARING WALLS:

FLOOR CONSTRUCTION:

ROOF CONSTRUCTION:

USE GROUP: FLOOR NUMBER: STRUCTURAL FRAME: 0 HR 0 HR NLB WALLS AND PARTITIONS:

0 HR

0 HR

APPLICABLE CODES 2018 VIRGINIA CONSTRUCTION CODE, VUSBC PART I & PART II ADDITION BUILT IN 1979 2018 VIRGINIA EXISTING BUILDING CODE, LEVEL 2 ALTERATIONS

PER SECTIONS 601.2.2, 602 & 603 2018 VIRGINIA STATEWIDE FIRE PREVENTION CODE 2018 VIRGINIA ENERGY CONSERVATION CODE 2018 VIRGINIA PLUMBING CODE 2018 VIRGINIA MECHANICAL CODE 2017 NFPA 70 NATIONAL ELECTRIC CODE 2010 ADA STANDARDS FOR ACCESSIBLE DESIGN, SEPTEMBER 15, 2010 CONSTRUCTION & PROFESSIONAL SERVICES MANUAL

PROPOSED AREA OF WORK

(CPSM 2022 REV 0)

B - BUSINESS USE GROUP OF BUILDING: B / A3 MIXED USE, NON-SEPARATED TYPE OF CONSTRUCTION: VB AREA OF RENOVATION: 260 GSF TENANT INFORMATION: VDOT EXISTING BUILDING

OCCUPANT LOAD TABULATION: BUSINESS (1:100) FIRST FLOOR 2,142 SF/100 =22 BASEMENT 816 SF/100 = 9ASSEMBLY (1:15) FIRST FLOOR 163 SF/15 =11 BASEMENT 683 SF/15 =46 STORAGE (1:300) FIRST FLOOR 230 SF/300 = 1

EXISTING - UNCHANGED BASEMENT 821 SF/300 = 3

THERE IS NO CHANGE TO THE EXISTING USE, OCCUPANCY CLASSIFICATION, OCCUPANT LOAD OR EGRESS RELATED TO THIS RESTROOM RENOVATION PROJECT.

PROPOSED AREA OF WORK (CONTINUED)

TOILET CALCULATIONS PER 2018 VCC

ON 7-14-2022, DEB APPROVED A WAIVER REQUEST TO RECALCULATE THE OCCUPANT LOAD FOR THE PURPOSE OF RECALCULATING THE REQUIRED NUMBER OF PLUMBING FIXTURES IN THE PETERSBURG RESIDENCY OFFICE BUILDING THE APPROVED WAIVER WILL ALLOW THE RESTROOMS TO BE MADE ADA COMPLIANT AND INCLUDE THE INSTALLATION OF REQUIRED BABY CHANGING STATIONS IN THE EXISTING RESTROOMS.

ASSEMBLY: 57 OCCUPANTS (846 SF / 15) 20 OCCUPANTS (2,958 SF / 150) **BUSINESS:** STORAGE: 4 OCCUPANTS (1,051 SF / 300) TOTAL OCCUPANTS: 81 OCCUPANTS (24 "B" USE / 57 "A" USE)

TOILETS: "B" USE = 24 / 25 = 1 TOILET (.50 PER SEX) "A" USE = 28 / 65 W + 29 / 125 M = .43 W + .23 M TOTAL = .93 W, .73 M (1 TOILET PER SEX)LAVATORIES: "B" USE = 24 / 40 = 0.6 LAVS (0.3 PER SEX) "A" USE = 57 / 200 = 0.3 LAVS (0.15 PER SEX) TOTAL = 0.3 + 0.15 = 0.45 LAV PER SEX (1 LAV PER SEX) TOTAL BUILDING: 2 TOILETS (1 PER SEX)

2 LAVATORIES (1 PER SEX)

INDEX OF DRAWINGS

T002 COVER SHEET PART II

- A101 PETERSBURG RESIDENCY FIRST FLOOR PARTIAL DEMOLITION PLAN & PARTIAL REFLECTED CEILING DEMOLITION PLAN
- A102 PETERSBURG RESIDENCY BASEMENT PARTIAL DEMOLITION PLAN & PARTIAL FLOOR PLAN
- A103 PETERSBURG RESIDENCY FIRST FLOOR PARTIAL FLOOR PLAN & PARTIAL REFLECTED CEILING PLAN
- A104 PETERSBURG RESIDENCY DETAILS A105 SOUTH HILL RESIDENCY FIRST FLOOR PARTIAL DEMOLITION PLAN & PARTIAL
- REFLECTED CEILING DEMOLITION PLAN A106 SOUTH HILL RESIDENCY BASEMENT
- PARTIAL DEMOLITION PLAN SOUTH HILL RESIDENCY FIRST FLOOR PARTIAL FLOOR PLAN & PARTIAL
- REFLECTED CEILING PLAN A108 SOUTH HILL RESIDENCY DETAILS

PLUMBING

- P001 COVER SHEET PETERSBURG - DEMOLITION & NEW
- WORK FLOOR PLAN SOUTH HILL - DEMOLITION & NEW
- WORK FLOOR PLAN

PETERSBURG - RISER DIAGRAMS P302 SOUTH HILL - RISER DIAGRAMS


MECHANICAL

M001 COVER SHEET

M101 PETERSBURG - DEMOLITION & NEW WORK FLOOR PLAN M102 SOUTH HILL - DEMOLITION & NEW

WORK FLOOR PLAN

M601 SCHEDULES & DETAILS

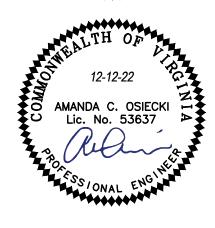

12-12-22

RALPH HOFFMAN

Lic. No. 018804

12-12-22

STEPHANIE B. STEIN

Lic. No. 15957


REVIS	IONS		
NO.	DATE	DESCRIPTION	

DRAWING NUMBER

IFB # 157389

INSULATION; INSULATED

INTERIOR

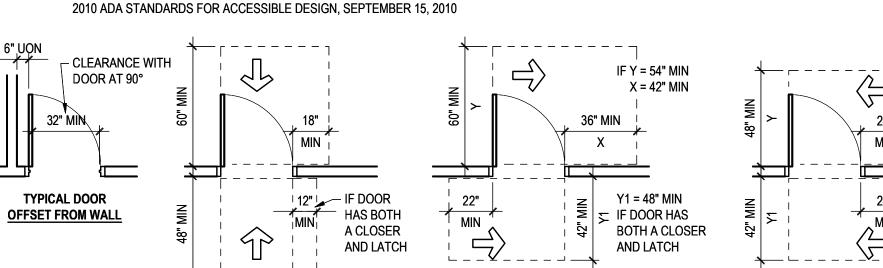

AND LATCH


TYPICAL DOOR CLEARANCES

Y = 54" MIN IF DOOR HAS A CLOSER MIN | IF DOOR HAS LATCH SIDE APPROACH

ALL DOOR CLEARANCES SHALL BE IN ACCORDANCE WITH

HINGE SIDE APPROACH


AND LATCH

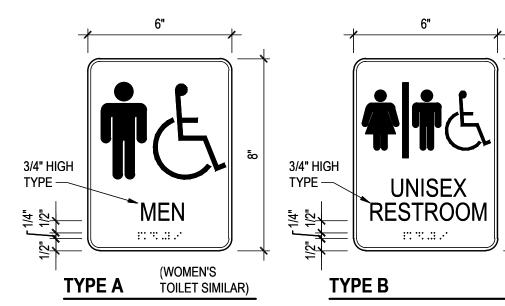

3/4" HIGH TYPE — UNISEX RESTROOM :: ':: .:: .· TYPE C

NOTES: MOUNT SIGNS AT 54" AFF TO CENTER. PROVIDE SIGNAGE LETTERING AND BRAILLE IN ACCORDANCE WITH 2010 ADA STANDARDS FOR ACCESSIBLE DESIGN, SEPTEMBER 15, 2010

AD08-01

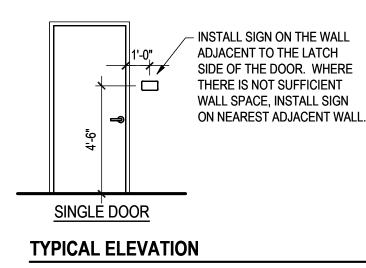

SIGN DETAILS



GAUTHIER ALVARADO ASSOCIATES

703-241-2202 WWW.GAA-AE.COM

(NO ASBESTOS PRESENT) AN INSPECTION TO IDENTIFY ASBESTOS-CONTAINING MATERIALS HAS BEEN CONDUCTED AND CAN BE FOUND AS PART OF "APPENDIX A" TO THE PROJECT SPECIFICATIONS. NO MATERIALS CONTAINING ASBESTOS WERE IDENTIFIED BY THE REPORT FOR THE BUILDING. SHOULD THE CONTRACTOR ACCESS ANY MATERIAL SUSPECTED OF CONTAINING ASBESTOS NOT IDENTIFIED BY THESE REPORTS, HE SHALL STOP WORK IN THE IMMEDIATE AREA AND NOTIFY THE OWNER (VDOT).

STATEMENTS

THE REMOVAL OF ASBESTOS MATERIALS IS NOT TO BE CONDUCTED WITHOUT THE OWNERS ASBESTOS PROJECT MONITOR BEING ON-SITE.

LEAD STATEMENT: BUILDING #4230004


ASBESTOS STATEMENT: BUILDING #4230004

AN INSPECTION TO IDENTIFY LEAD COATED BUILDING COMPONENTS HAS BEEN CONDUCTED AND CAN BE FOUND AS PART OF "APPENDIX A" TO THE PROJECT SPECIFICATIONS. THIS REPORT IS PROVIDED FOR THE CONTRACTOR'S USE AND MAY NOT BE ALL INCLUSIVE. IT IS THE CONTRACTOR'S RESPONSIBILITY TO COMPLY WITH ALL VIRGINIA OCCUPATIONAL SAFETY AND HEALTH (VOSH) REGULATIONS AS THEY PERTAIN TO EMPLOYEE EXPOSURE TO LEAD.


ALL LEAD AND LEAD COATED BUILDING COMPONENTS SHALL BE RECYCLED TO THE EXTENT POSSIBLE.

GAUTHIER, ALVARADO & ASSOCIATES ASSUMES NO RESPONSIBILITY FOR THE ADEQUACY OR ACCURACY OF THE ASBESTOS AND LEAD INSPECTION REPORTS CONTAINED IN THE CONTRACT DOCUMENTS AS THIS INFORMATION WAS PREPARED BY VDOT. THE CONTRACTOR SHALL ADDRESS ANY RELATED QUESTIONS TO THE VDOT REPRESENTATIVE.

SOUTH HILL RESIDENCY MAPS

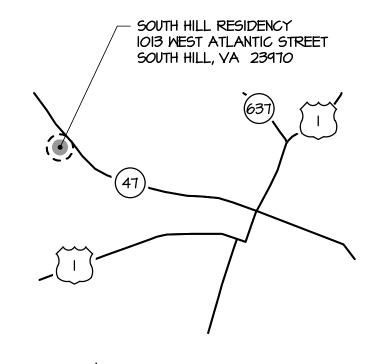

VICINITY MAP

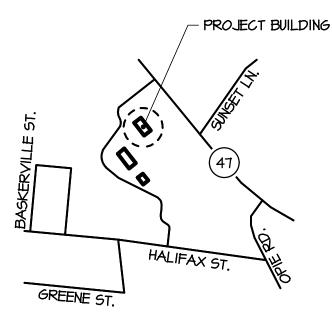

LOCATION MAP

SOUTH HILL RESIDENCY BUILDING DATA

EXISTING BUILDING INFORM	MATION
ORIGINAL BLDG CODE AND YEAR: YEAR BUILT:	VUSBC, BOCA NBC 1984 1988
USE GROUP OF BUILDING:	B / A-3 MIXED USE, NON-SEPARATED
TYPE OF CONSTRUCTION:	3A
NUMBER OF STORIES:	2
HIGH RISE BUILDING:	NO
FIRST FLOOR AREA:	3,686 SF
BASEMENT FLOOR AREA:	3,698 SF
TOTAL BUILDING FLOOR AREA:	7,384 SF
FIRST FLOOR OCCUPANT LOAD:	48 OCCUPANTS
BASEMENT OCCUPANT LOAD:	115 OCCUPANTS
TOTAL BUILDING OCCUPANT LOAD): 163 OCCUPANTS

APPROVED CENTRAL STATION: NO FIRE ALARM SYSTEM: STANDPIPES: **EXISTING FIRE RATING REQUIREMENTS** STRUCTURAL FRAME: 2 HR EXTERIOR BEARING WALLS: INTERIOR BEARING WALLS:

EXISTING FIRE PROTECTION SYSTEM

SPRINKLERS:

0 HR NLB WALLS AND PARTITIONS: 1 HR EXIST UL DESIGN FLOOR CONSTRUCTION: G502 ROOF CONSTRUCTION: 1 HR

APPLICABLE CODES 2018 VIRGINIA CONSTRUCTION CODE, VUSBC PART I & PART II 2018 VIRGINIA EXISTING BUILDING CODE, LEVEL 2 ALTERATIONS PER SECTIONS 601.2.2, 602 & 603 2018 VIRGINIA STATEWIDE FIRE PREVENTION CODE

2018 VIRGINIA ENERGY CONSERVATION CODE 2018 VIRGINIA PLUMBING CODE 2018 VIRGINIA MECHANICAL CODE 2017 NFPA 70 NATIONAL ELECTRIC CODE 2010 ADA STANDARDS FOR ACCESSIBLE DESIGN, SEPTEMBER 15, 2010

CONSTRUCTION & PROFESSIONAL SERVICES MANUAL

PROPOSED AREA OF WORK

TYPE OF CONSTRUCTION: IIIA

AREA OF RENOVATION: 262 GSF

(CPSM 2022, REV 0)

USE GROUP:

FLOOR NUMBER: TENANT INFORMATION: VDOT EXISTING BUILDING OCCUPANT LOAD TABULATION: EXISTING - UNCHANGED BUSINESS (1:100) FIRST FLOOR 3,491 SF/100 = 35 BASEMENT 1,708 SF/100 = 18 ASSEMBLY (1:15) FIRST FLOOR 195 SF/15 = 13 BASEMENT 1,420 SF/15 = 95 STORAGE (1:300) BASEMENT 570 SF/300 = 2

B - BUSINESS

USE GROUP OF BUILDING: B / A-3 MIXED USE, NON-SEPARATED

THERE IS NO CHANGE TO THE EXISTING USE, OCCUPANCY CLASSIFICATION, OCCUPANT LOAD OR EGRESS RELATED TO THIS RESTROOM RENOVATION PROJECT.

DESCRIPTION OF WORK

THROUGH C405 AND C408.

RESTROOM RENOVATIONS TO PROVIDE ADA COMPLIANCE AND BABY CHANGING STATIONS WITH ASSOCIATED FINISH, HVAC AND ELECTRICAL WORK.

HIGH PERFORMANCE BUILDING ACT

IN ACCORDANCE WITH THE HIGH PERFORMANCE BUILDING ACT, THE BUILDING IS EXEMPT FROM COMPLIANCE BECAUSE THE COST OF THE RENOVATIONS DOES NOT EXCEED 50% OF THE VALUE OF THE BUILDING.

VIRGINIA ENERGY CONSERVATION CODE IN ACCORDANCE WITH THE VIRGINIA ENERGY CONSERVATION CODE (VECC), THE BUILDING SHALL COMPLY WITH VECC SECTIONS C402

TOILET & LAVATORY CALCULATIONS PER 2018 VCC

ON 7-14-2022, DEB APPROVED A WAIVER REQUEST TO RECALCULATE THE OCCUPANT LOAD FOR THE PURPOSE OF RECALCULATING THE REQUIRED NUMBER OF PLUMBING FIXTURES IN THE SOUTH HILL RESIDENCY OFFICE BUILDING. THE APPROVED WAIVER WILL ALLOW THE RESTROOMS TO BE MADE ADA COMPLIANT AND INCLUDE THE INSTALLATION OF REQUIRED BABY CHANGING STATIONS IN THE EXISTING RESTROOMS.

ASSEMBLY: 108 OCCUPANTS (1,615 SF / 15) 35 OCCUPANTS (5,199 SF / 150) BUSINESS: 2 OCCUPANTS (570 SF / 300) STORAGE:

TOTAL OCCUPANTS: 145 OCCUPANTS (37 "B" USE / 108 "A" USE)

TOILETS: "B" USE = 37 / 25 = 1.48 TOILETS (0.74 PER SEX) "A" USE = 54 / 65 W + 54 / 125 M = .83 W + .43 M TOTAL = 1.57 W, 1.17 M (2 TOILETS PER SEX) LAVATORIES: "B" USE = 37 / 40 = 0.9 LAVS (0.45 PER SEX) "A" USE = 108 / 200 = 0.5 LAVS (0.25 PER SEX) TOTAL = 0.45 + 0.25 = 0.7 LAV PER SEX (1 LAV PER SEX)


TOTAL BUILDING: 4 TOILETS (2 FOR WOMEN & 2 FOR MEN) 2 LAVATORIES (1 PER SEX)

PROJECT TITLE

VIRGINIA DEPARTMENT OF **TRANSPORTATION**

> State Project No. 501-B2501-012

PETERSBURG & **SOUTH HILL RESIDENCY RESTROOM RENOVATIONS**

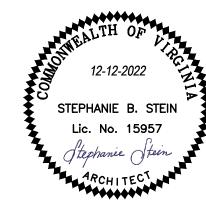

REVISIONS

NO. DATE

DESCRIPTION

GAA PROJECT NO. 768-E1 DRAWN BY SS CHECKED BY JH

DRAWING TITLE


COVER SHEET 2

12-12-2022

PROJECT STATUS

PERMIT SUBMISSION

DRAWING NUMBER

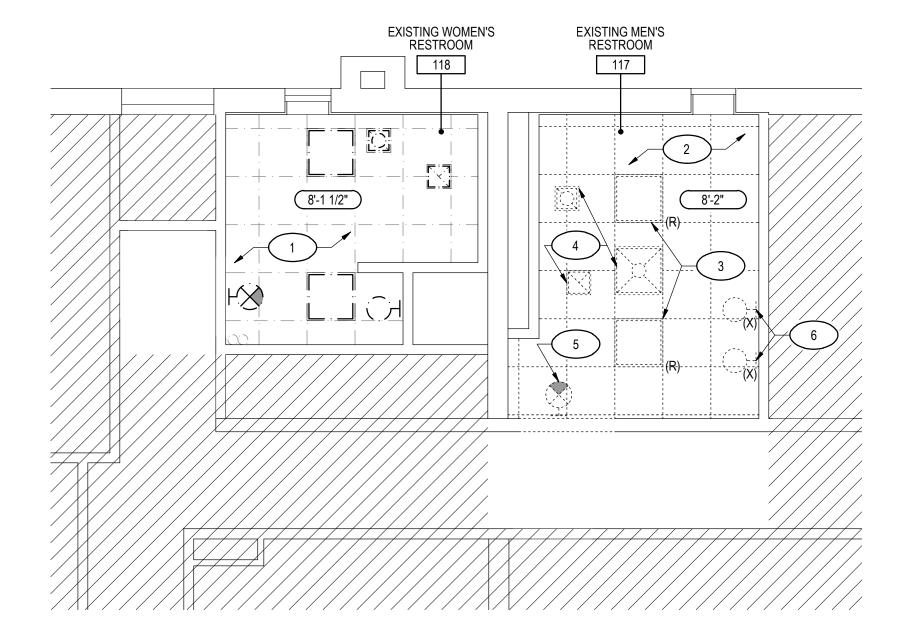

PETERSBURG RESIDENCY FIRST FLOOR PARTIAL REFLECTED CEILING DEMOLITION PLAN 1/4" = 1'-0"

CEILING DEMOLITION PLAN LEGEND:

	EXISTING 2' x 2' SUSPENDED ACOUSTICAL PANEL CEILING		HVAC DIFFUSER, SEE MECH DWGS
	REMOVE 2' x 2' SUSPENDED ACOUSTICAL PANEL CEILING CEILING HEIGHT ABOVE	© ₩	EXISTING LIGHT FIXTURES TO REMAIN
<u>8'-0"</u>	FINISH FLOOR	<u></u> Ю Ю	EXISTING LIGHT FIXTURES TO BE REMOVED OR RELOCATED

CEILING DEMOLITION PLAN KEY NOTES:

1	EXISTING CEILING GRID, CEILING TILES, LIGHT FIXTURES, EXHAUST FAN, HVAC DIFFUSER, WALL MOUNTED EXIT SIGN & ASSOCIATED ACCESSORIE TO REMAIN THROUGHOUT
2	REMOVE CEILING GRID, CEILING TILES & ASSOCIATED ACCESSORIES THROUGHOUT
3	REMOVE LIGHT FIXTURES & MAINTAIN FOR REINSTALLATION.
4	REMOVE HVAC DIFFUSERS & EXHAUST FAN
5	REMOVE EXISTING EXIT SIGN & MAINTAIN FOR REINSTALLATION. MAINTAIN EXISTING BRANCH CIRCUIT WIRING & CONDUIT.
6	REMOVE LIGHT FIXTURES. MAINTAIN EXISTING BRANCH CIRCUIT WIRING & CONDUIT FOR NEW FIXTURES.

GENERAL DEMOLITION NOTES

- 1. THIS PLAN IS NOT A COMPLETE REPRESENTATION OF ALL THE EXISTING CONDITIONS. THIS PLAN IS SCHEMATIC IN NATURE AND INTENDS TO SHOW THE GENERAL EXTENT AND LAYOUT OF THE EXISTING FACILITY.
- 2. REMOVE EXISTING CONSTRUCTION CLEANLY AND LEAVE EXISTING CONSTRUCTION TO REMAIN READY TO RECEIVE NEW WORK.
- 3. REMOVE EXISTING CONSTRUCTION, INCLUDING MECHANICAL, PLUMBING, ELECTRICAL WORK ETC., AS NECESSARY AND
- WHEREEVER NECESSARY TO PROVIDE WORK IN ACCORDANCE WITH THE CONTRACT DOCUMENTS.
- 4. REMOVE EXISTING FLOOR FINISHES AND/OR PREPARE FLOORS TO BE LEVEL AND READY FOR REPLACEMENT WITH NEW FINISH AS SCHEDULED OR WITH NEW MATERIAL NOTED.
- 5. EXISTING WOMEN'S RESTROOM: WHERE EXISTING CERAMIC WALL TILE AND/OR BASE ARE REMOVED, THESE SHALL BE CAREFULLY REMOVED, CLEANED AND SALVAGED FOR RE-USE IN OTHER AREAS THAT REQUIRE MATCHING CERAMIC TILE WALL AND BASE FINISH AS NEW CONSTRUCTION.
- 6. REMOVE MISCELLANEOUS METALS, HOOKS, NAILS, ETC., FROM WALLS AND FLOORS.
- 7. REMOVE EXISTING CABINETS, COAT HOOKS, PLUMBING, MECHANICAL, ELECTRICAL WORK, ETC. AS REQUIRED, SALVAGE ITEMS AS INDICATED AND/OR DIRECTED BY OWNER.
- 8. AS DIRECTED BY THE OWNER REMOVE, BOX, LABEL, AND DELIVER TO OWNER, MISCELLANEOUS ITEMS OR EQUIPMENT DESIGNATED FOR REMOVAL OR LOCATED ON SURFACES WHICH ARE NECESSARY TO BE REMOVED, UNLESS INDICATED FOR RELOCATION.
- 9. REMOVE EXISTING TOILET PARTITIONS, TOILET ACCESSORIES AND PLUMBING FIXTURES WHERE INDICATED, INCLUDING RELATED PIPING AS REQUIRED. SALVAGE EXISTING CERAMIC TILE WHEREVER POSSIBLE TO PATCH EXISTING WALLS IN THE EXISTING WOMEN'S RESTROOM.
- 10. EXISTING MEN'S RESTROOM: REMOVE EXISTING CEILINGS AND ALL RELATED ACCESSORIES IN THEIR ENTIRETY WHERE INDICATED.



G A U T H I E R A L V A R A D O A S S O C I A T E S

703-241-2202 WWW.GAA-AE.COM

PROJECT TITLE

VIRGINIA DEPARTMENT OF TRANSPORTATION

State Project No. 501-B2501-012

PETERSBURG &
SOUTH HILL
RESIDENCY
RESTROOM
RENOVATIONS



NO.	DATE	DESCRIPTION
GAA PRO	JECT NO.	768-E1
DRAWN B	SY SS	<u> </u>

DATE 12-12-2022

CHECKED BY JH

DRAWING TITLE

REVISIONS

ARCHITECTURAL


PETERSBURG RESIDENCY
FIRST FLOOR PARTIAL
DEMOLITION PLAN & PARTIAL
REFLECTED CEILING
DEMOLITION PLAN
PROJECT STATUS

PERMIT SUBMISSION

DRAWING NUMBER


A10⁴

FILE: 76801-4101 DATE: 12/13/22

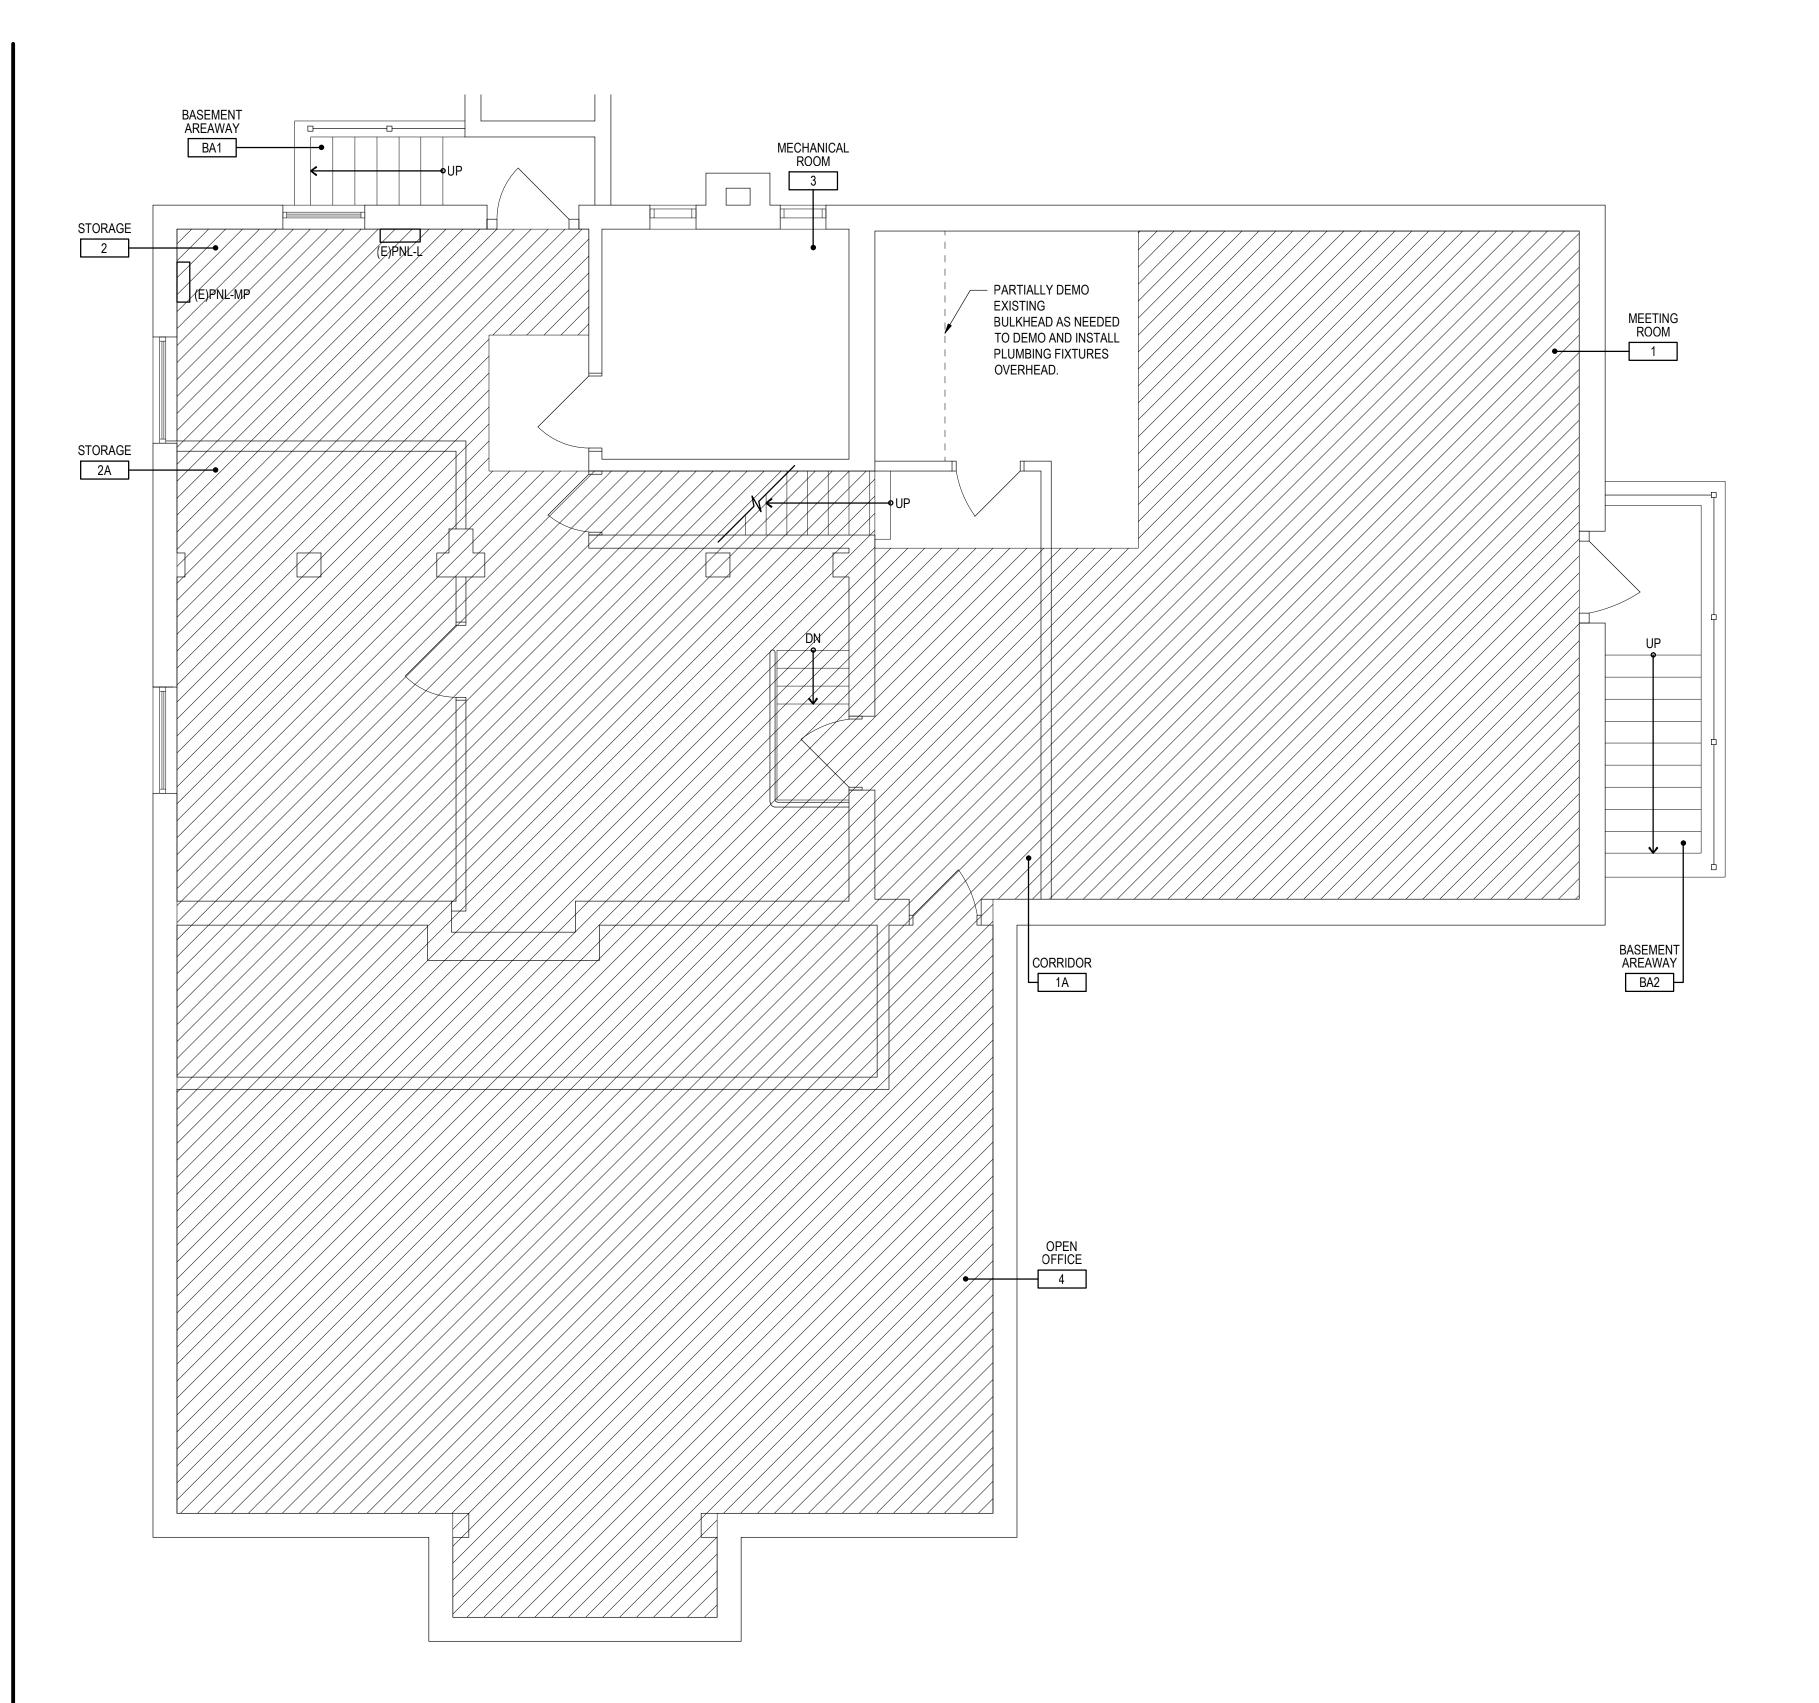


PETERSBURG RESIDENCY BASEMENT
PARTIAL DEMOLITION PLAN

1/4" = 1'-0"

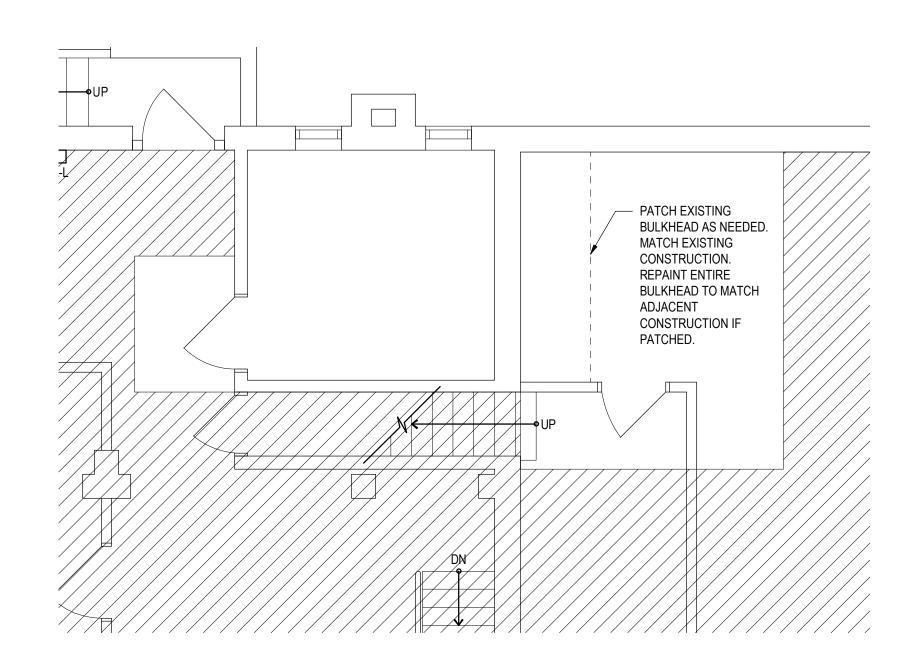

PETERSBURG RESIDENCY BASEMENT PARTIAL FLOOR PLAN 1/4" = 1'-0"

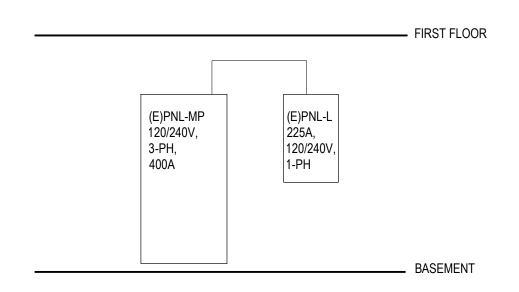

EXISTING POWER RISER DIAGRAM



A S S O C I A T E S


703-241-2202
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PROJECT TITLE

VIRGINIA DEPARTMENT OF TRANSPORTATION

State Project No. 501-B2501-012

PETERSBURG & SOUTH HILL RESIDENCY RESTROOM RENOVATIONS

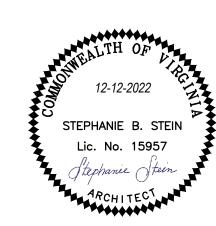

NO. DATE DESCRIPTION

GAA PROJECT NO. 768-E1
DRAWN BY SS

CHECKED BY JH

DATE 12-12-2022

DRAWING TITLE

ARCHITECTURAL


PETERSBURG RESIDENCY
BASEMENT PARTIAL
DEMOLITION PLAN & PARTIAL
FLOOR PLAN

PROJECT STATUS

PERMIT SUBMISSION

DRAWING NUMBER

A102

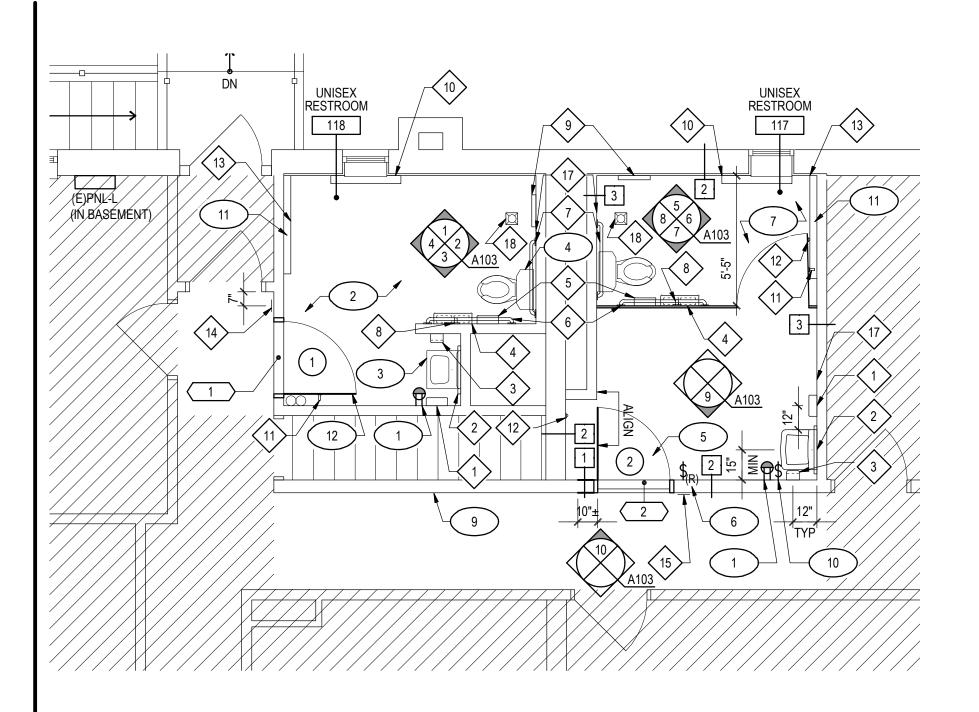

LEGEND:

ROOM DESIGNATION 101 ROOM NUMBER

DOOR WITH DOOR NUMBER PARTITION TYPE

RESTROOM ACCESSORY / EQUIPMENT NUMBER


KEY NOTE NUMBER

FLOOR TRANSITION DESIGNATION. SEE DETAILS ON A104.

- WALL ELEVATION NUMBER (IF NOT THE SAME)

GROUND FAULT INTERRUPTING DUPLEX RECEPTACLE, NEMA 5-20R

LIGHT SWITCH

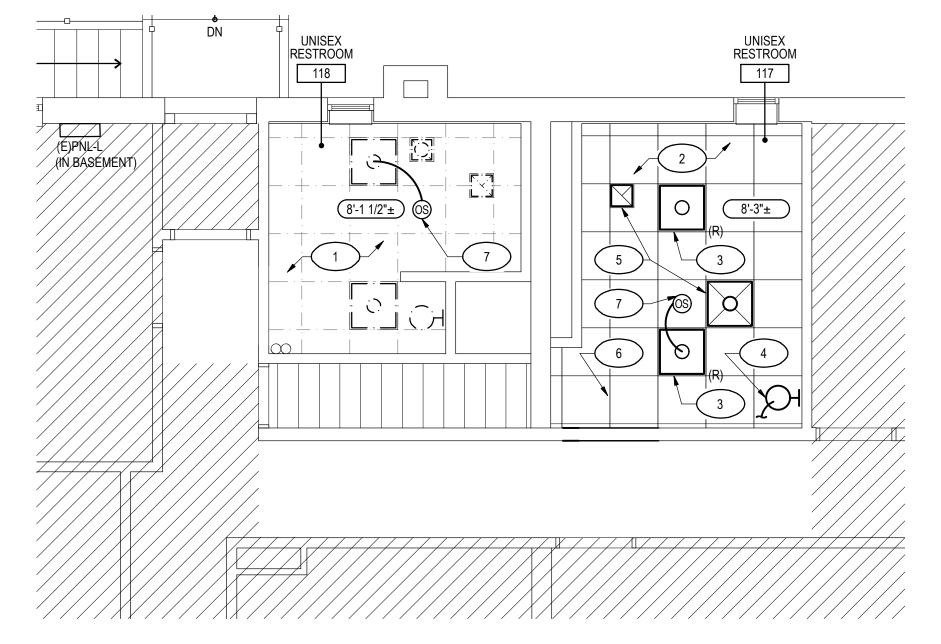

SENSORSWITCH CMR-PDT-9

LEGEND:

8'-0"

EXISTING 2' x 4' SUSPENDED ACOUSTICAL PANEL CEILING

ACOUSTICAL PANEL CEILING

WIRING: 2 #12, 1 #12 GND IN 3/4" CONDUIT, U.O.N.

TO REMAIN THROUGHOUT


HVAC DIFFUSER & EXHAUST FAN


DOOR & DOOR FRAME

2' x 2' SUSPENDED

FINISH FLOOR

CEILING PLAN KEY NOTES:

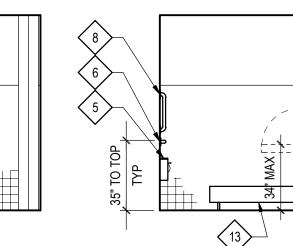


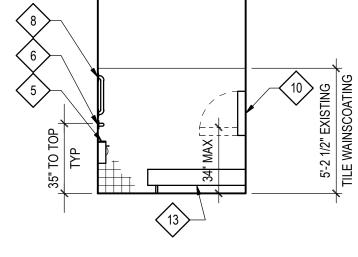

UNISEX RESTROOM


118 ELEVATION

118 ELEVATION 118 ELEVATION **118 ELEVATION** EXISTING WINDOW & TRIM TO REMAIN. REPAINT & RECAULK TRIM.

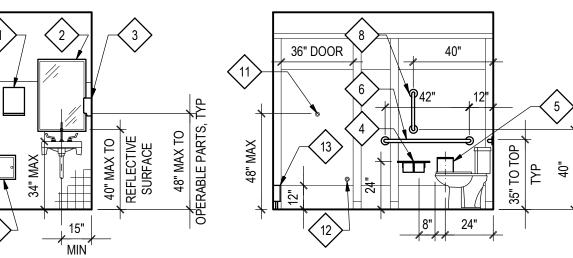

UNISEX RESTROOM 117 ELEVATION



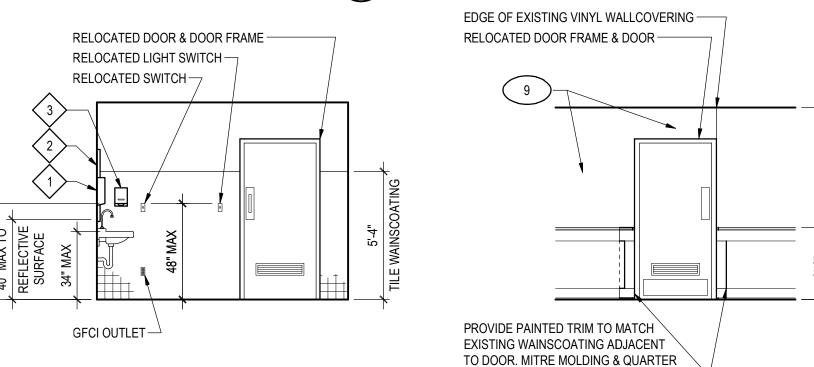

UNISEX RESTROOM 117 ELEVATION

UNISEX RESTROOM 117 ELEVATION

PETERSBURG RESIDENCY FIRST FLOOR PARTIAL FLOOR PLAN

GENERAL PLAN NOTES

- SEE DRAWING A104 FOR PARTITION TYPES.
- 2. SEE DETAIL 10/A104 FOR THROUGH-PENETRATION FIRESTOP DETAIL AT FLOOR.

DOOR FRAME DETAIL NOTES

- COORDINATE FRAME SIZE WITH WALL/ PARTITION THICKNESS.
- 2. PROVIDE A MINIMUM OF 3 ANCHORS PER JAMB.
- 3. APPLY SEALANT AROUND THE ENTIRE FRAME PERIMETER OF INTERIOR FRAME ON BOTH SIDES OF THE WALL. SEALANT APPLICATION AT INTERIOR FRAME SHOULD CLOSE THE GAP BETWEEN THE WALL SURFACE AND THE FRAME AND SHOULD NOT CREATE A COVE AT THIS JUNCTURE.

PARTITION NOTES

- 1. PROVIDE TILE BACKER GYP BD AT ALL LOCATIONS WHERE CERAMIC WALL TILE
- 2. PROVIDE MOISTURE RESISTANT GYP BD AT ALL LOCATIONS WHERE WATER OR WASTE LINES OCCUR.
- 3. PROVIDE FIRE RETARDANT WOOD BLOCKING FOR ALL WALL HUNG ITEMS (GRAB BARS, SHELVING, MILLWORK, HARDWARE, MOUNTING BRACKETS, ETC). 4" WIDE 16 GAUGE FLAT GALVANIZED STEEL BACKING MAY BE USED IN LIEU OF FIRE RETARDANT WOOD BLOCKING. BACKING SHALL SPAN AT LEAST THREE STUDS.
- 4. PROVIDE APPROPRIATE METAL TRIM ACCESSORIES FOR GYP BD PER INDUSTRY STANDARDS OR AS SPECIFIED ON THESE DRAWINGS.
- 5. ALL GYP BD PARTITIONS SHALL BE TAPED, SPACKLED, AND SANDED SMOOTH WITH NO VISIBLE JOINTS AND MADE READY TO RECEIVE SPECIFIED FINISHES.
- 6. ALL PARTITIONS ABUTTING EXISTING BUILDING COLUMNS OR WALLS SHALL ALIGN NEW FINISH FACE WITH EXISTING UNLESS OTHERWISE NOTED. REMOVE EXISTING CORNER BEAD AND PROVIDE A SMOOTH TRANSITION.
- 7. REMOVE EXISTING GYP BD AS NECESSARY FOR A SMOOTH FINISH WITH NO VISIBLE TRANSITION FROM EXISTING TO NEW GYP BD.
- 8. PATCH ALL EXISTING GYP BD SURFACES AND REFINISH TO PROVIDE A SMOOTH SURFACE READY TO RECEIVE SPECIFIED FINISHES.

RESTROOM ACCESSORY & EQUIPMENT LIST:

PAPER TOWEL DISPENSER, MIRROR, 24"x36"

W/ INTEGRATED SHELF

18" VERTICAL GRAB BAR

TOILET SEAT COVER DISPENSER,

42" GRAB BAR

SOAP DISPENSER, 4" DEPTH MAX

DUEL TOILET PAPER DISPENSER

DOOR BUMPER, MAX 1-1/2" DEPTH. COORDINATE LOCATION W/ DOOR PULL OR BASEBOARD

COAT HOOK, 4" DEPTH MAX

BABY CHANGING STATION, 4" DEPTH MAX

RADIATOR WHERE APPLICABLE.

BASEBOARD RADIATOR UNISEX RESTROOM SIGNAGE, TYPE C

SANITARY NAPKIN DISPOSAL

UNISEX RESTROOM SIGNAGE, TYPE B

12" x 12" ACCESS PANEL. VERIFY LOCATION IN FIELD WHERE ACCESS IS NEEDED.

FLOOR DRAIN. SEE PLUMBING DRAWINGS.

SEE DETAIL 5/A104.

FLOOR PLAN KEY NOTES:

4" DEPTH MAX

PROVIDE GFCI DUPLEX RECEPTACLE AT EXISTING BACK BOX

PATCH FLOOR SLAB, FLOOR TILE, WALL TILE & PAINTED GYPSUM WALL BOARD TO MATCH EXISTING WHERE ITEMS WERE REMOVED OR RELOCATED.

RELOCATED SINK. 34" AFF MAX TO COUNTER

RELOCATED TOILET

WOOD DOOR, WOOD DOOR FRAME & DOOR HARDWARE. PROVIDE DOOR TRIM TO MATCH EXISTING. RELOCATE EXISTING FLOOR FINISH AT DOOR THRESHOLD TO NEW DOOR LOCATION. PATCH & PAINT ADJACENT WALL TO MATCH EXISTING, INCLUDING WOOD WAINSCOATING.

REINSTALL EXISTING LIGHT SWITCH, 46" AFF TO CENTERLINE

PROVIDE PAINTED GYPSUM WALL BOARD, FLOOR TILE & WALL TILE THROUGHOUT. PROVIDE TOILET PARTITIONS, TOILET PARTITION DOORS & TOILET ACCESSORIES WHERE INDICATED.


WHERE WALLCOVERING IS REMOVED, PREP WALL SURFACE & PROVIDE SKIM COAT AS REQUIRED TO PROVIDE SMOOTH SURFACE. PAINT WALL TO MATCH EXISTING TO EXTENT SHOWN.

REINSTALL EXISTING LIGHT SWITCH ABOVE GFCI RECEPTACLE, 46" AFF TO CENTERLINE

PROVIDE NEW FLOOR PENETRATIONS FOR BASEBOARD RADIATOR & PATCH EXISTING PENETRATIONS AS NEEDED. COORDINATE LOCATION OF FLOOR PENETRATIONS WITH PURCHASED EQUIPMENT. SEE MECHANICAL DRAWINGS.

WOOD DOOR, WOOD DOOR FRAME & DOOR HARDWARE. PROVIDE DOOR TRIM TO MATCH EXISTING.

PETERSBURG RESIDENCY FIRST FLOOR PARTIAL REFLECTED CEILING PLAN

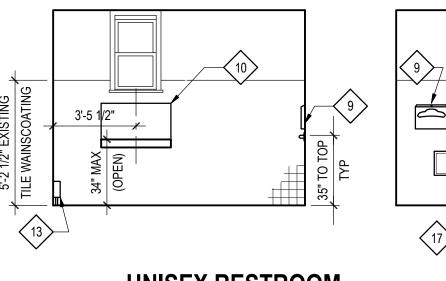

UNISEX RESTROOM

UNISEX RESTROOM

UNISEX RESTROOM

UNISEX RESTROOM 117 ELEVATION

UNISEX RESTROOM

117 ELEVATION

ROUND AT EXPOSED EDGE.—

GAUTHIER ALVARADO ASSOCIATES

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LIGHT FIXTURES

OCCUPANCY SENSOR

Ю

EXISTING CEILING GRID, CEILING PANELS, LIGHT FIXTUERS, EXHAUST FAN,

HVAC DIFFUSER. WALL MOUNTED EXIT SIGN & ASSOCIATED ACCESSORIES

REINSTALL EXISTING 2'x2' LIGHT FIXTURES. CONNECT TO EXISTING BRANCH

WALL MOUNTED LIGHT FIXTURE. CIRCUIT TO NEAREST 120V BRANCH CIRCUIT WIRING & CONNECT TO EXISTING SWITCH FOR CONTROL. BASIS OF DESIGN:

REINSTALL EXISTING WALL MOUNTED EXIT SIGN, CENTERED ABOVE RELOCATED

PROVIDE CEILING MOUNTED OCCUPANCY SENSOR. BASIS OF DESIGN: LUTRON

LOS-CDT-2000-WH WITH POWER PACK AS NEEDED TO OPERATE. CIRCUIT TO

EXISTING FIXTURES FOR CONTROL. ALTERNATES: LEGRAND LMDC-100,

PROVIDE CEILING GRID, CEILING PANELS & ASSOCIATED ACCESSORIES

LITHONIA FMVCSL-24IN-MVOLT-30K-90CRI-BN. ALTERNATE FIXTURE 1:

LITECONTROL 67L-W-D. ALTERNATE FIXTURE 2: WAC LIGHTING WS-77624.


THROUGHOUT IN SAME LOCATION AS REMOVED CEILING GRID

PROJECT TITLE

VIRGINIA DEPARTMENT OF TRANSPORTATION

> State Project No. 501-B2501-012

PETERSBURG & **SOUTH HILL RESIDENCY** RESTROOM **RENOVATIONS**

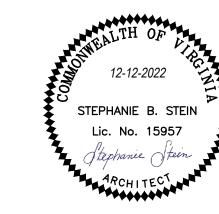

REVISIONS NO. DATE DESCRIPTION

GAA PROJECT NO. 768-E1

CHECKED BY JH 12-12-2022

DRAWN BY SS

DRAWING TITLE


ARCHITECTURAL PETERSBURG RESIDENCY


FIRST FLOOR PARTIAL FLOOR PLAN & PARTIAL REFLECTED **CEILING PLAN**

PROJECT STATUS

PERMIT SUBMISSION

DRAWING NUMBER

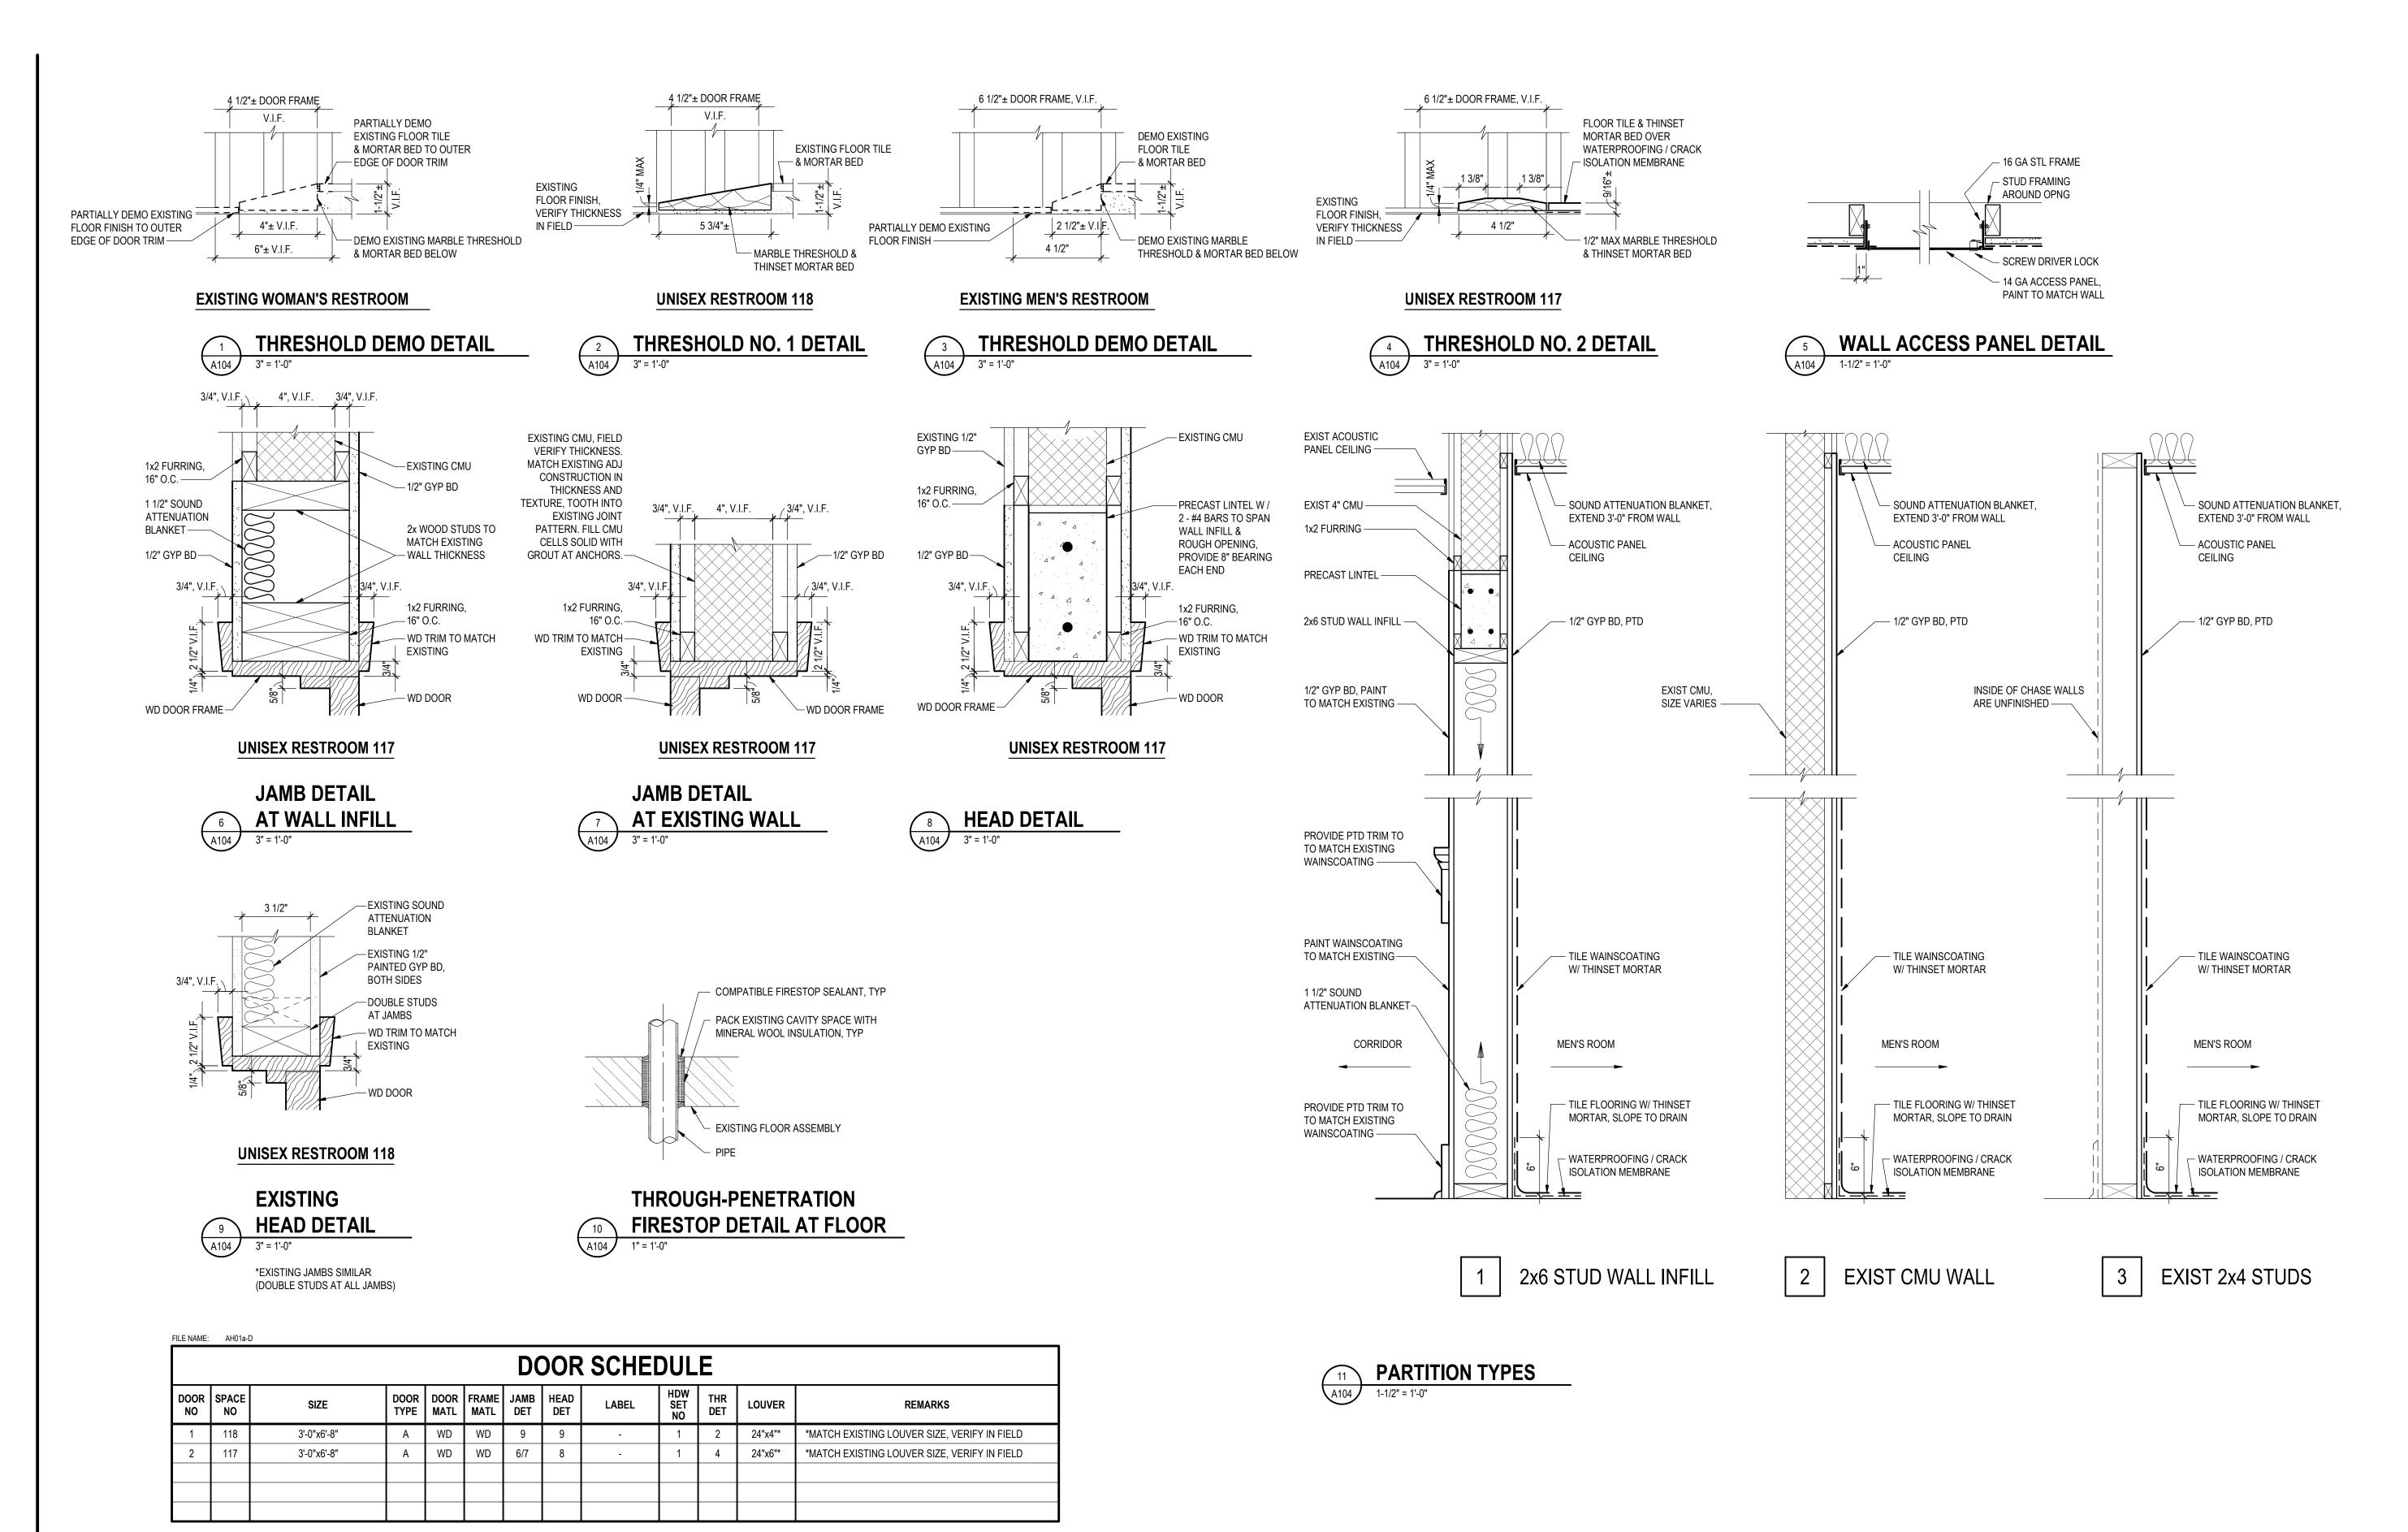

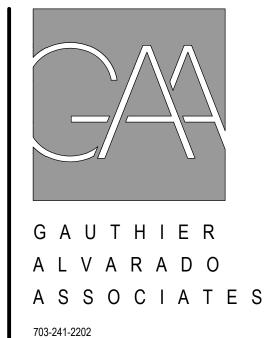

PROJECT TITLE

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VIRGINIA DEPARTMENT OF TRANSPORTATION

> State Project No. 501-B2501-012

PETERSBURG & **SOUTH HILL RESIDENCY** RESTROOM **RENOVATIONS**



REVISIONS

NO. DATE DESCRIPTION

GAA PROJECT NO. 768-E1 DRAWN BY SS

CHECKED BY JH 12-12-2022

DRAWING TITLE

ARCHITECTURAL PETERSBURG RESIDENCY **DETAILS**

PROJECT STATUS

PERMIT SUBMISSION

DRAWING NUMBER


A104

DOOR SCHEDULE NOTES

1. ALL DOORS ARE 1-3/4" THICK UNLESS OTHERWISE NOTED.


2. UNDERCUT ALL DOORS TO CLEAR FLOOR FINISHES AND TO CLEAR THRESHOLD BY 1/2" AT TOILET ROOMS, UNLESS OTHERWISE NOTED.

3. DOOR HARDWARE FINISH TO MATCH EXISTING

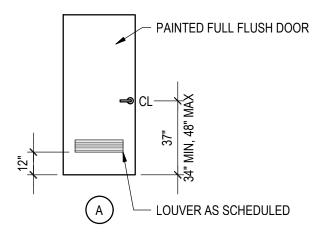

HARDWARE SET NO. 1 1 PRIVACY LOCKSET WITH INDICATOR 1 SURFACE MOUNTED CLOSER 1 WALL MOUNTED DOOR STOP 3 SILENCERS 1 KICKPLATE

DOOR TYPE

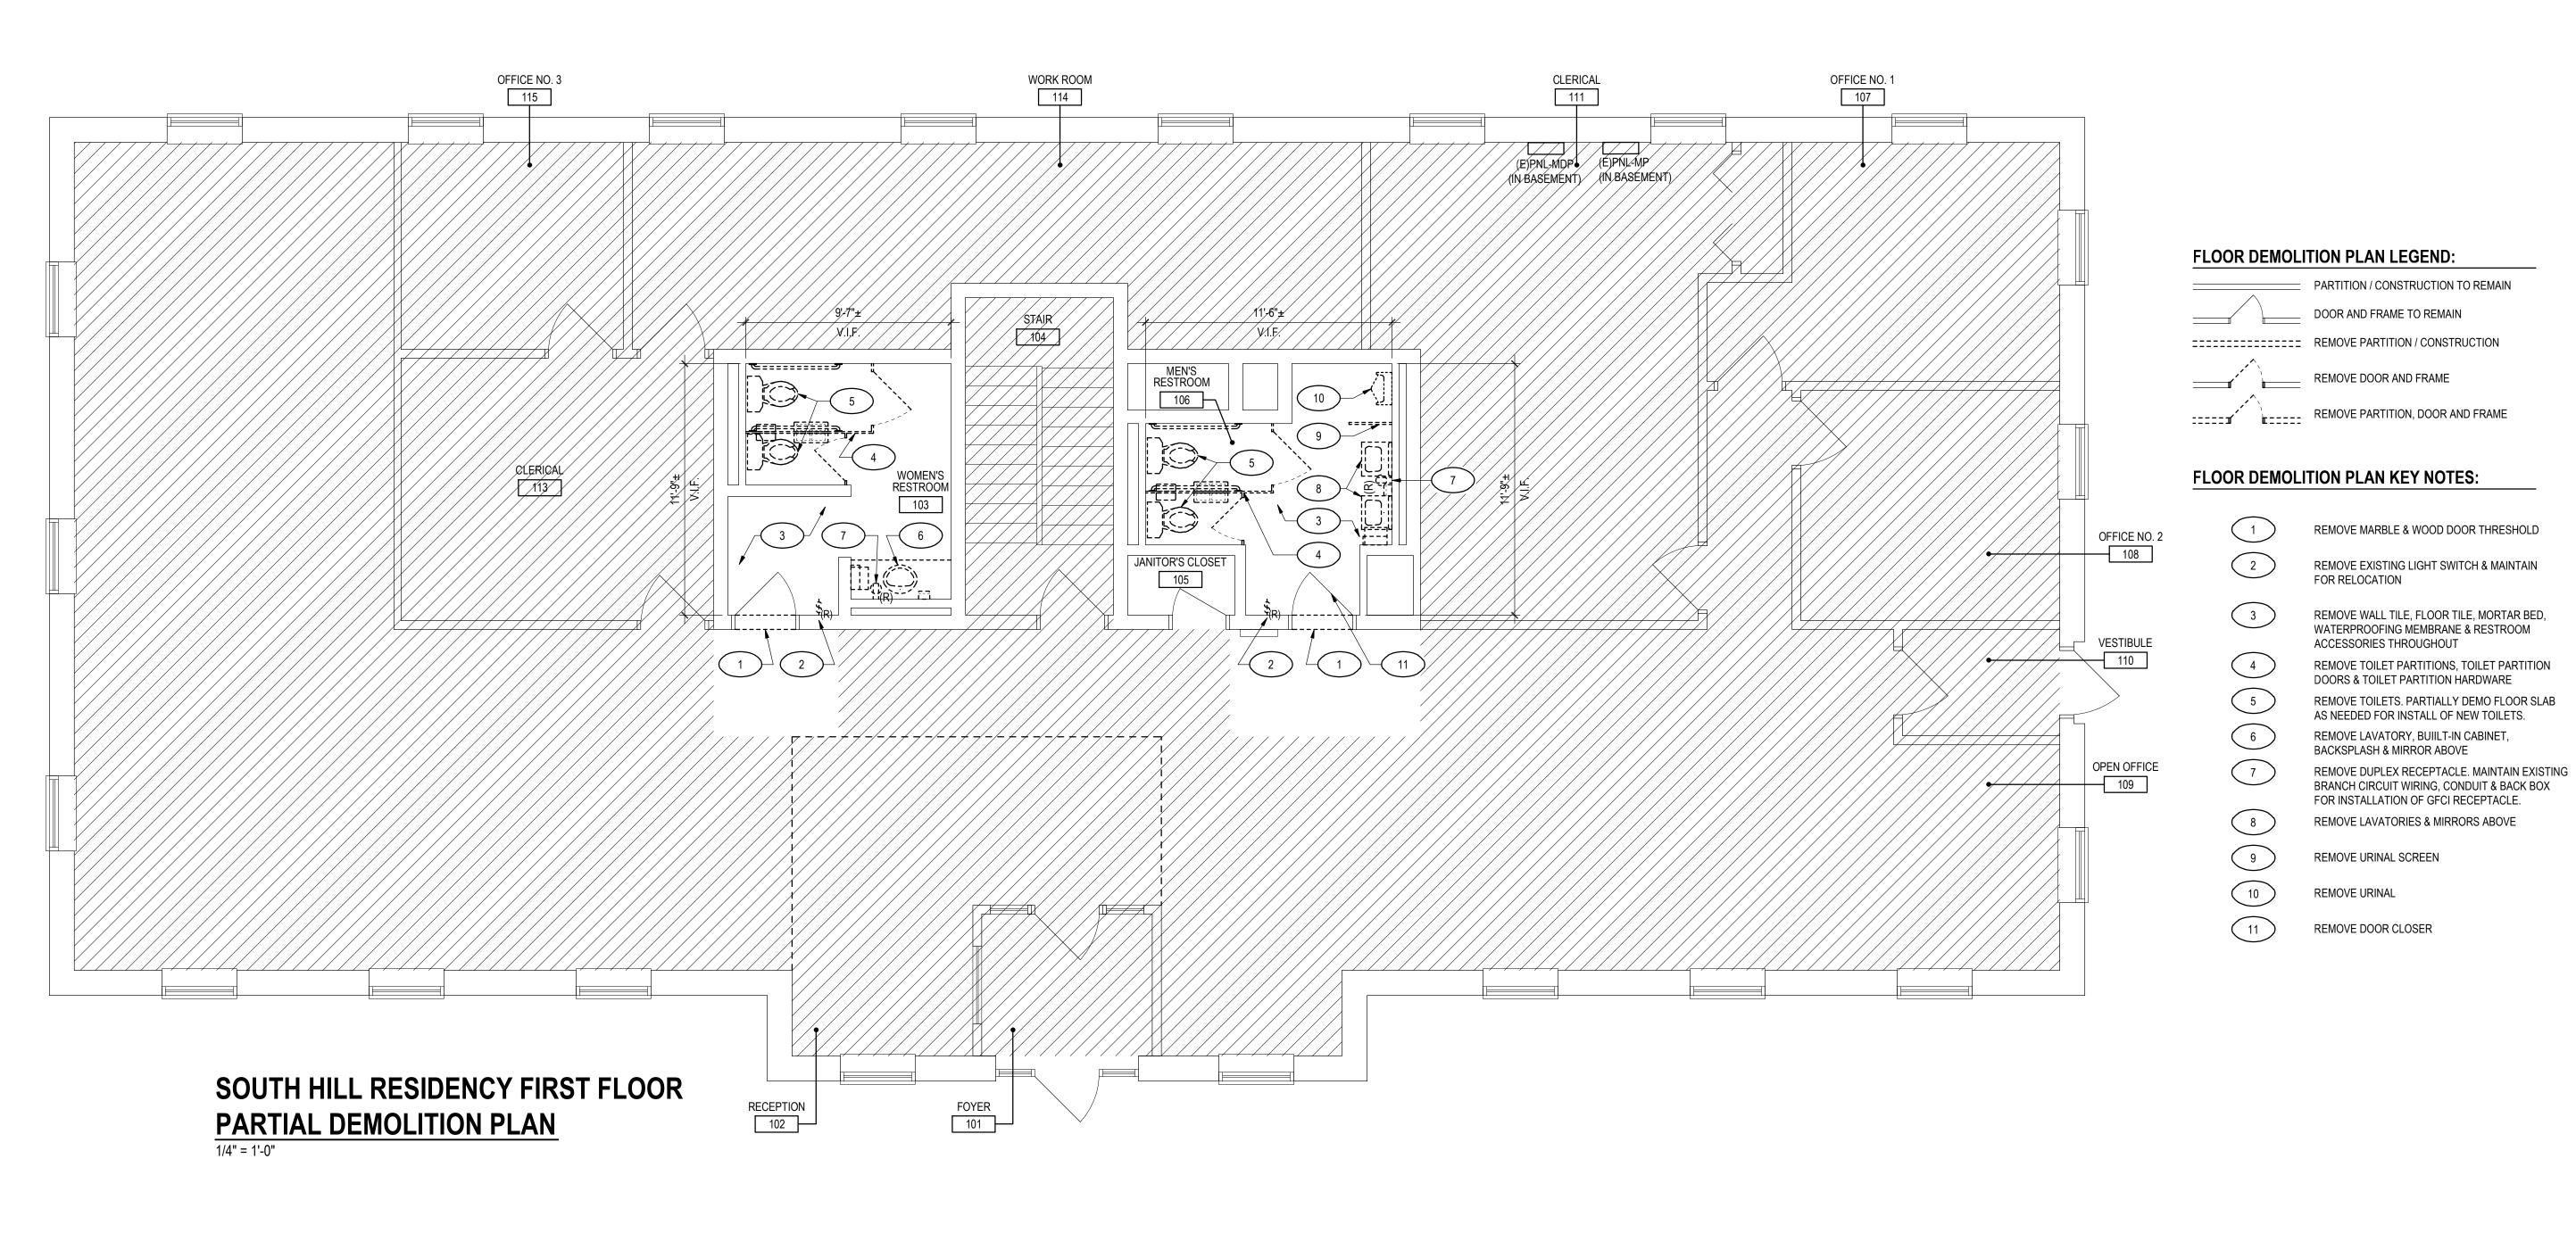

HVAC DIFFUSER,


SEE MECH DWGS

EXISTING

LIGHT FIXTURES

TO BE REMOVED

[3]

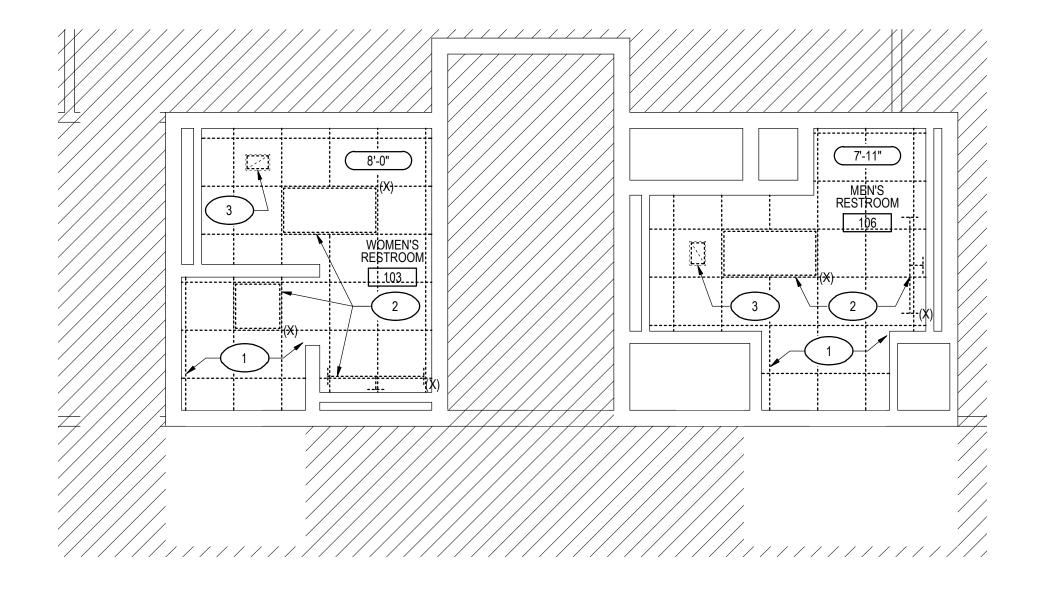

}--

CEILING DEMOLITION PLAN KEY NOTES:

NOT INDICATED

CEILING HEIGHT ABOVE

FINISH FLOOR, SEE FINISH

SCHEDULE FOR SPACES

CEILING DEMOLITION PLAN LEGEND:

REMOVE 2' x 2' SUSPENDED

ACOUSTICAL PANEL CEILING

1 REMOVE CEILING GRID, CEILING TILES & ASSOCIATED ACCESSORIES THROUGHOUT

REMOVE EXISTING LIGHT FIXTURES.
MAINTAIN EXISTING BRANCH CIRCUIT WIRING &
CONDUIT FOR CONNECTION TO NEW FIXTURES.

3 REMOVE HVAC DIFFUSER


SOUTH HILL RESIDENCY FIRST FLOOR

PARTIAL REFLECTED CEILING DEMOLITION PLAN

1/4" = 1'-0"

GENERAL DEMOLITION NOTES

- 1. THIS PLAN IS NOT A COMPLETE REPRESENTATION OF ALL THE EXISTING CONDITIONS. THIS PLAN IS SCHEMATIC IN NATURE AND INTENDS TO SHOW THE GENERAL EXTENT AND LAYOUT OF THE EXISTING FACILITY.
- 2. REMOVE EXISTING CONSTRUCTION CLEANLY AND LEAVE EXISTING CONSTRUCTION TO REMAIN READY TO RECEIVE NEW WORK.
- 3. REMOVE EXISTING CONSTRUCTION, INCLUDING MECHANICAL, PLUMBING, ELECTRICAL WORK ETC., AS NECESSARY AND WHEREEVER NECESSARY TO PROVIDE WORK IN ACCORDANCE WITH THE CONTRACT DOCUMENTS.
- 4. REMOVE EXISTING FLOOR FINISHES AND/OR PREPARE FLOORS TO BE LEVEL AND READY FOR REPLACEMENT WITH NEW FINISH AS SCHEDULED OR WITH NEW MATERIAL NOTED.
- 5. REMOVE MISCELLANEOUS METALS, HOOKS, NAILS, ETC., FROM WALLS AND
- 6. REMOVE EXISTING CABINETS, COAT HOOKS, PLUMBING, MECHANICAL, ELECTRICAL WORK, ETC. AS REQUIRED, SALVAGE ITEMS AS INDICATED AND/OR DIRECTED BY OWNER.
- 7. AS DIRECTED BY THE OWNER REMOVE, BOX, LABEL, AND DELIVER TO OWNER, MISCELLANEOUS ITEMS OR EQUIPMENT DESIGNATED FOR REMOVAL OR LOCATED ON SURFACES WHICH ARE NECESSARY TO BE REMOVED, UNLESS INDICATED FOR RELOCATION.
- 8. REMOVE EXISTING TOILET PARTITIONS, TOILET ACCESSORIES AND PLUMBING FIXTURES WHERE INDICATED, INCLUDING RELATED PIPING AS REQUIRED.
- 9. REMOVE EXISTING CEILINGS AND ALL RELATED ACCESSORIES IN THEIR ENTIRETY WHERE INDICATED.

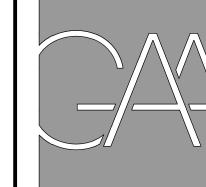

G A U T H I E R A L V A R A D O A S S O C I A T E S


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PROJECT TITLE

VIRGINIA DEPARTMENT OF TRANSPORTATION

State Project No. 501-B2501-012

PETERSBURG &
SOUTH HILL
RESIDENCY
RESTROOM
RENOVATIONS

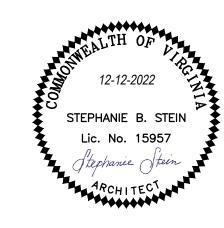

REVISIONS

NO. DATE

GAA PROJECT I	NO.	768-E1
DRAWN BY	SS	
CHECKED BY	JH	

12-12-2022

DESCRIPTION

DRAWING TITLE

ARCHITECTURAL

SOUTH HILL RESIDENCY FIRST FLOOR PARTIAL DEMOLITION PLAN & PARTIAL REFLECTED CEILING DEMOLITION PLAN

PROJECT STATUS


PERMIT SUBMISSION

DRAWING NUMBER

Δ105

IFB # 157389


FILE: 76801-A105 DATE: 12/13/22

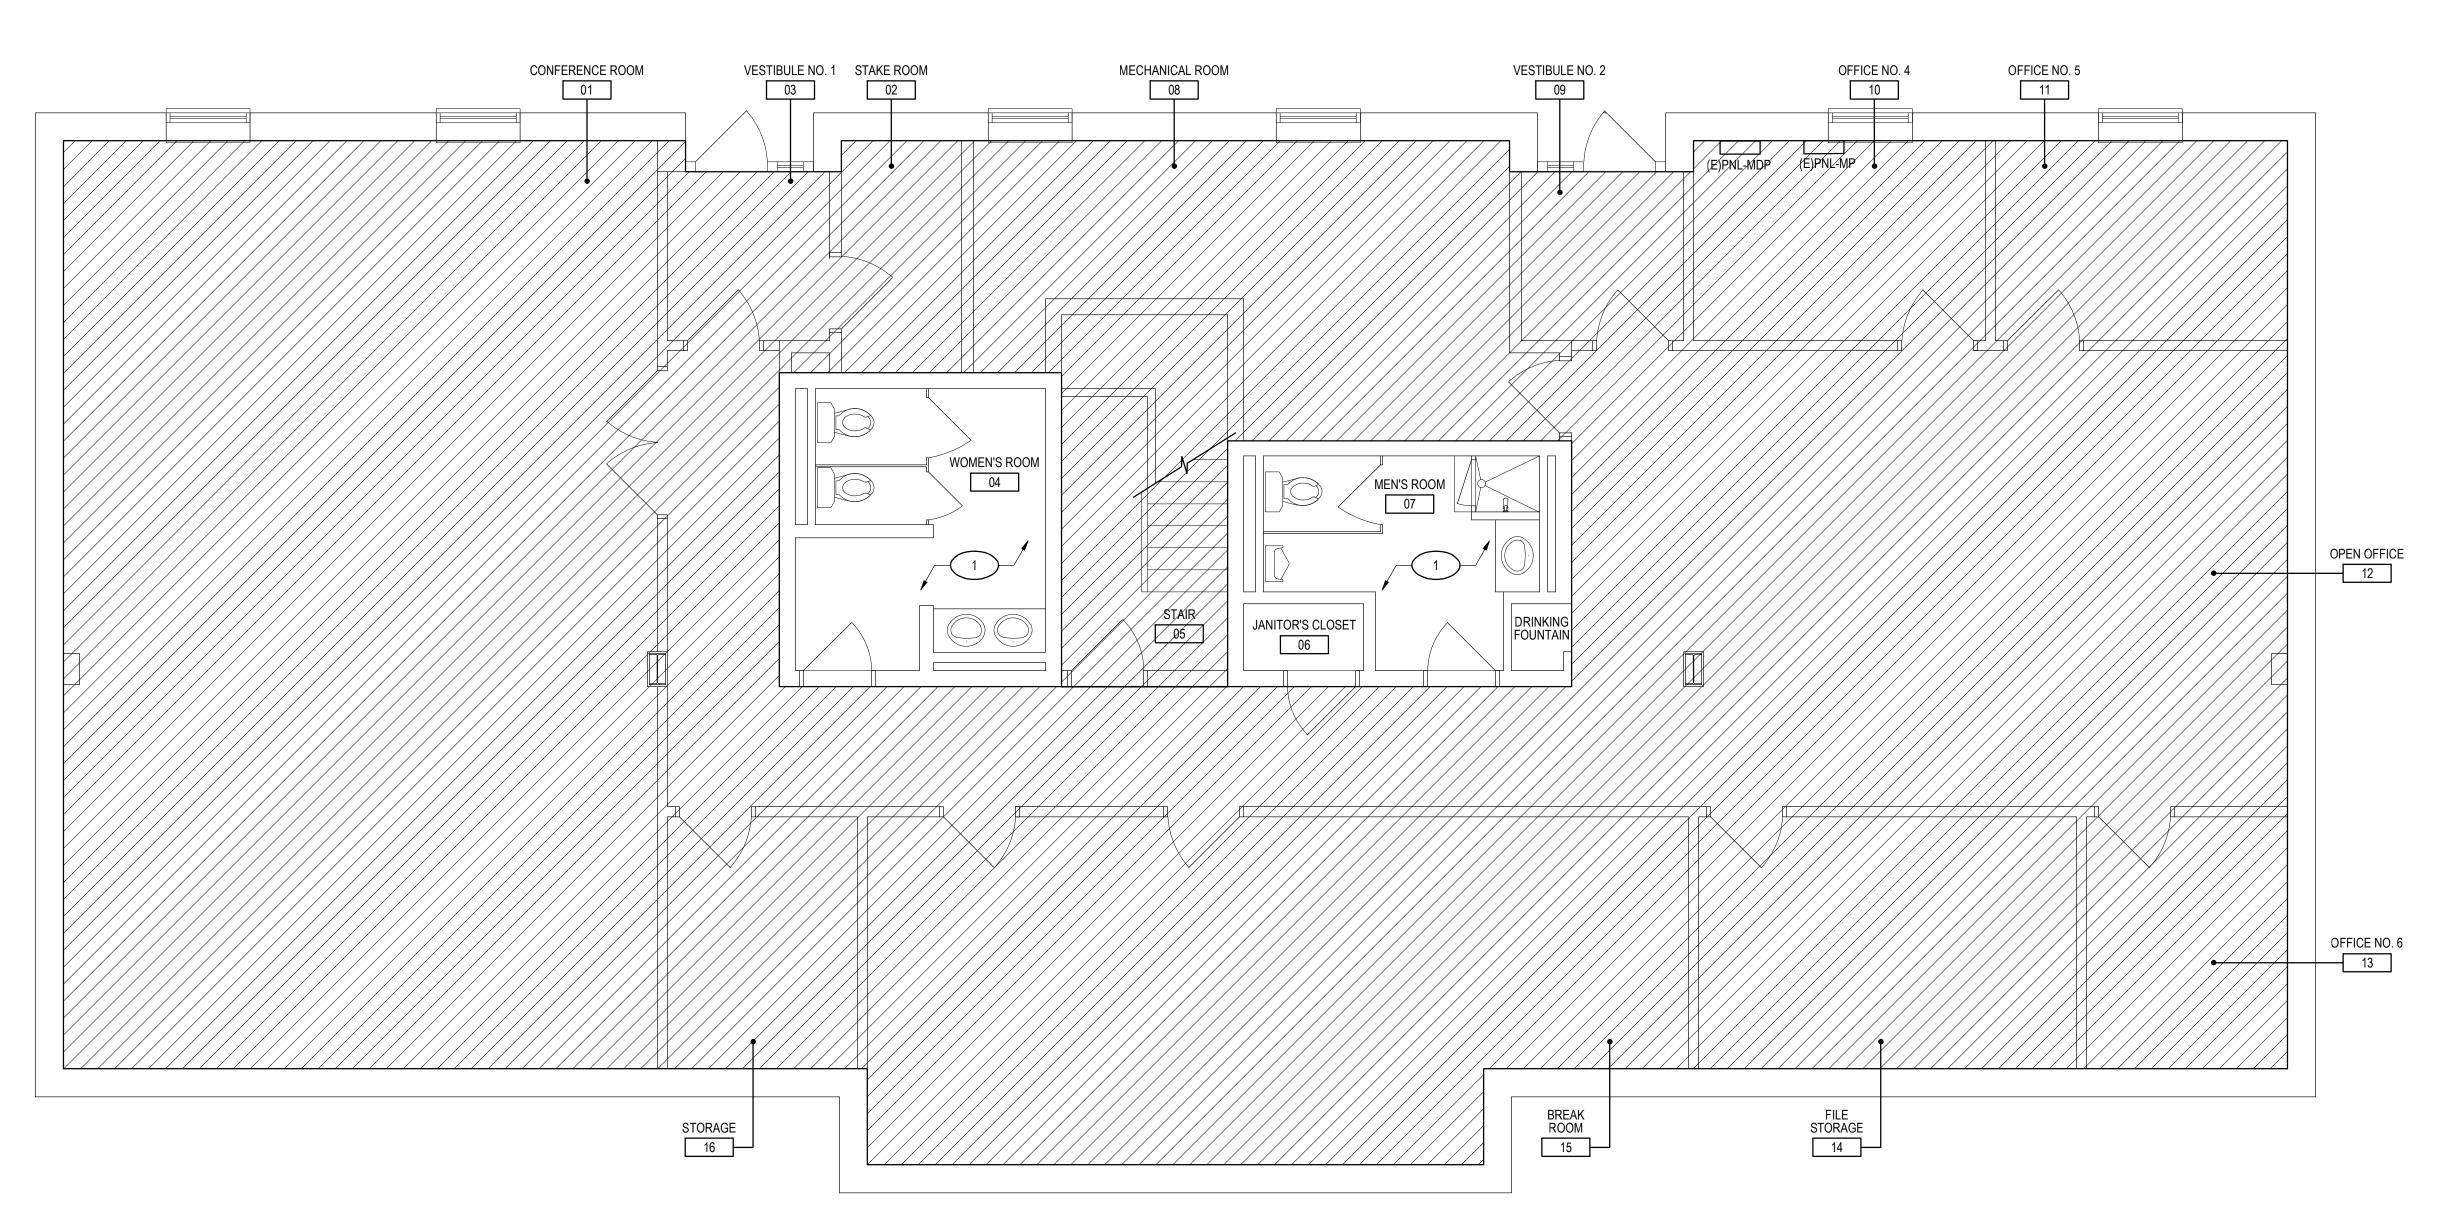

SOUTH HILL RESIDENCY BASEMENT PARTIAL DEMOLITION PLAN

PARTIAL DEMOLITION PLAN KEY NOTES

1 REMOVE AND REPLACE EXISTING 2x4 ACOUSTIC CEILING TILES TO ACCESS AND PERFORM WORK ABOVE. REPLACE TILES TO MATCH EXISTING IF DAMAGED DURING THE PERFORMANCE OF THE WORK.

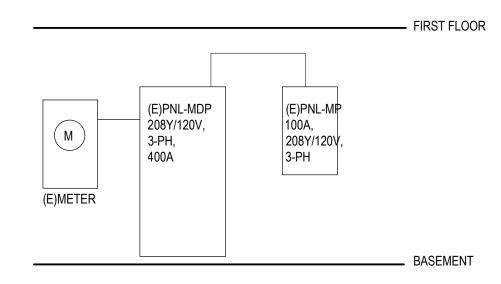

EXISTING POWER RISER DIAGRAM

NOT TO SCALE



ASSOCIATES


PROJECT TITLE

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VIRGINIA DEPARTMENT OF TRANSPORTATION

> State Project No. 501-B2501-012

PETERSBURG & **SOUTH HILL RESIDENCY RESTROOM RENOVATIONS**

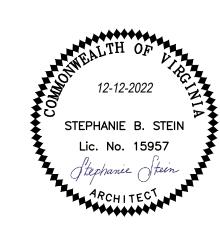

REVISIONS

NO. DATE

GAA PROJECT NO. 768-E1

DESCRIPTION

DRAWN BY SS CHECKED BY JH 12-12-2022

DRAWING TITLE


ARCHITECTURAL


SOUTH HILL RESIDENCY **BASEMENT PARTIAL DEMOLITION PLAN**


PROJECT STATUS

PERMIT SUBMISSION

DRAWING NUMBER

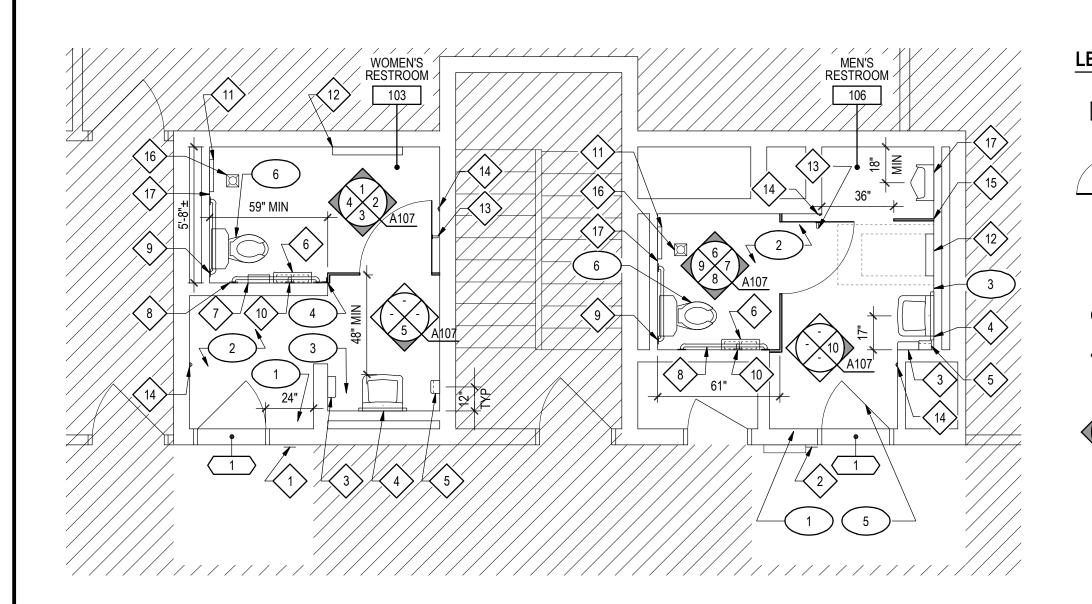

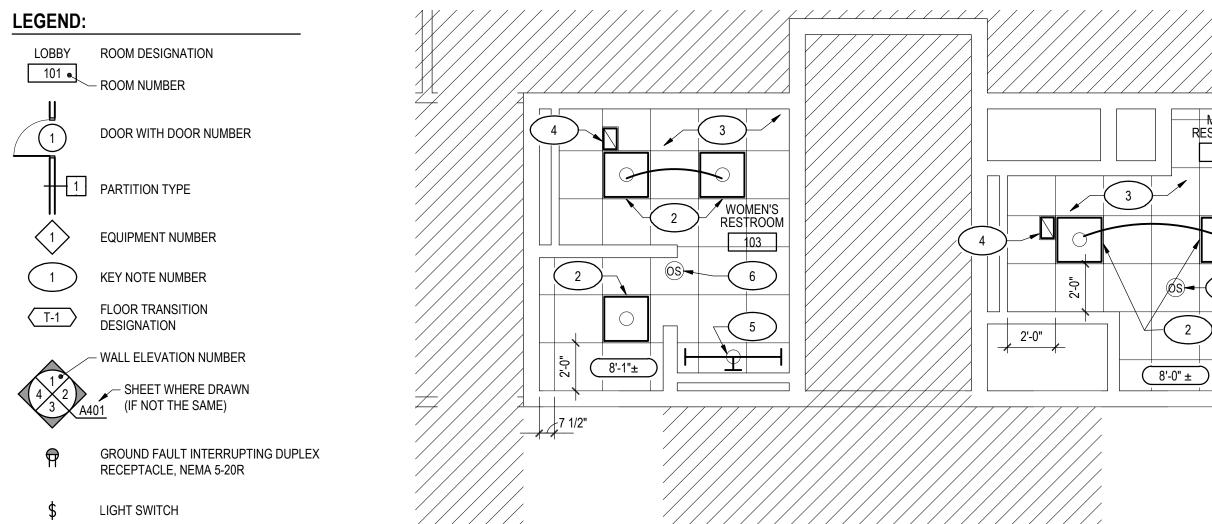

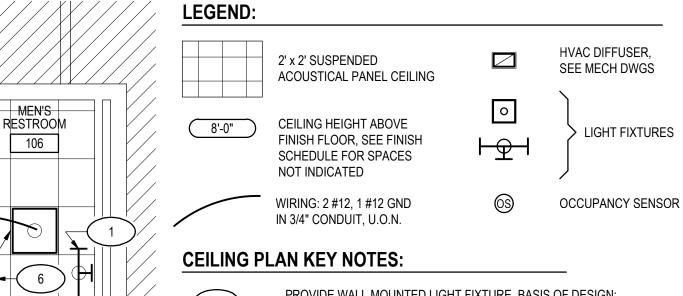


PROVIDE WALL MOUNTED LIGHT FIXTURE. BASIS OF DESIGN: LITHONIA FMVCSL-24IN-MVOLT-30K-90CRI-BN. CONNECT TO EXISTING BRANCH CIRCUIT WIRING AND CONDUIT. ALTERNATE FIXTURE 1: LITECONTROL 67L-W-D ALTERNATE FIXTURE 2: WAC LIGHTING WS-77624 PROVIDE 2' x 2' LIGHT FIXTURE. BASIS OF DESIGN: LITHONIA 2GTL-2-33L-SWL-MVOLT-EZ1-LP835. CIRCUIT TO

EXISTING LIGHTING BRANCH CIRCUIT IN THIS AREA AND EXTEND W/ 2 #12 + 1 #12 GND IN 3/4"C MINIMUM, MATCH EXISTING WIRE SIZE AND RATING. ALTERNATE FIXTURE 1: COLUMBIA LJT22 ALTERNATE FIXTURE 2: METALUX 22GR LED


PROVIDE CEILING GRID, CEILING PANELS & ASSOCIATED ACCESSORIES THROUGHOUT

> PROVIDE WALL MOUNTED LIGHT FIXTURE. BASIS OF DESIGN: LITHONIA FMVCSL-36IN-MVOLT-30K-90CRI-BN. CONNECT TO EXISTING BRANCH CIRCUIT WIRING AND CONDUIT. ALTERNATE FIXTURE 1: LITECONTROL 67L-W-D ALTERNATE FIXTURE 2: WAC LIGHTING WS-77624

PROVIDE CEILING MOUNTED OCCUPANCY SENSOR. BASIS OF DESIGN: LUTRON LOS-CDT-2000-WH OR APPROVED EQUAL, WITH POWER PACK AS NEEDED TO OPERATE CIRCUIT TO EXISTING FIXTURES FOR CONTROL.

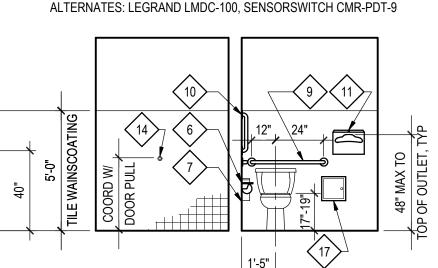

12-12-2022 STEPHANIE B. STEIN

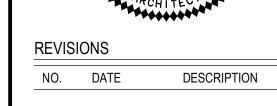

GAUTHIER

ALVARADO

703-241-2202 WWW.GAA-AE.COM

PROJECT TITLE

ASSOCIATES

VIRGINIA DEPARTMENT OF TRANSPORTATION

State Project No.

501-B2501-012

PETERSBURG &

SOUTH HILL

RESIDENCY

RESTROOM

RENOVATIONS

GAA PROJECT NO. 768-E1 DRAWN BY SS CHECKED BY JH

DRAWING TITLE

ARCHITECTURAL

12-12-2022

SOUTH HILL RESIDENCY FIRST FLOOR PARTIAL FLOOR PLAN & PARTIAL REFLECTED CEILING PLAN

PROJECT STATUS

PERMIT SUBMISSION

DRAWING NUMBER

A107

SOUTH HILL RESIDENCY FIRST FLOOR PARTIAL FLOOR PLAN

1/4" = 1'-0"

GENERAL PLAN NOTES

1. ALL PARTITIONS ARE TYPE 1 UNLESS OTHERWISE NOTED. SEE DRAWING A109 FOR PARTITION TYPES.

DOOR FRAME DETAIL NOTES

APPLY SEALANT AROUND THE ENTIRE FRAME PERIMETER OF INTERIOR FRAME ON RESTROOM SIDE OF THE WALL. SEALANT APPLICATION AT INTERIOR FRAME SHOULD CLOSE THE GAP BETWEEN THE WALL SURFACE AND THE FRAME AND SHOULD NOT CREATE A COVE AT THIS JUNCTURE.

RESTROOM ACCESSORY & EQUIPMENT LIST:

WOMEN'S RESTROOM SIGNAGE

MEN'S RESTROOM SIGNAGE

PAPER TOWEL DISPENSER, 4" DEPTH MAX

MIRROR, 24"x36"

SOAP DISPENSER, 4" DEPTH MAX

DUEL TOILET PAPER DISPENSER

W/ INTEGRATED SHELF SANITARY NAPKIN DISPOSAL

42" GRAB BAR

36" GRAB BAR

18" GRAB BAR

TOILET SEAT COVER DISPENSER, 4" DEPTH MAX

BABY CHANGING STATION, 4" DEPTH MAX IF LEADING EDGE MOUNTED HIGHER THAN 27" ABOVE FINISHED FLOOR

COAT HOOK, 4" DEPTH MAX

DOOR BUMPER, MAX 1-1/2" DEPTH. COORDINATE LOCATION W/ DOOR & DOOR PULL WHERE APPLICABLE.

20" x 48" URINAL SCREEN

FLOOR DRAIN. SEE PLUMBING DRAWINGS.

12"x12" ACCESS PANEL. VERIFY LOCATION IN FIELD WHERE ACCESS IS NEEDED. SEE DETAIL 5/A108.

FLOOR PLAN KEY NOTES:

REINSTALL EXISTING LIGHT SWITCH, 46" AFF TO CENTERLINE


TOILET PARTITION DOORS & TOILET ACCESSORIES


PROVIDE CONTINUOUS BRACKET FOR PRIVACY FROM TOILET PARTITION MANUFACTURER WHERE TOILET

PATCH DOOR & DOOR FRAME WHERE DOOR CLOSER WAS REMOVED

FLOOR ASSEMBLY IS FIRE RATED. PROVIDE UL THROUGH-PENETRATION FIRE STOP SYSTEM AT

SOUTH HILL RESIDENCY FIRST FLOOR PARTIAL REFLECTED CEILING PLAN

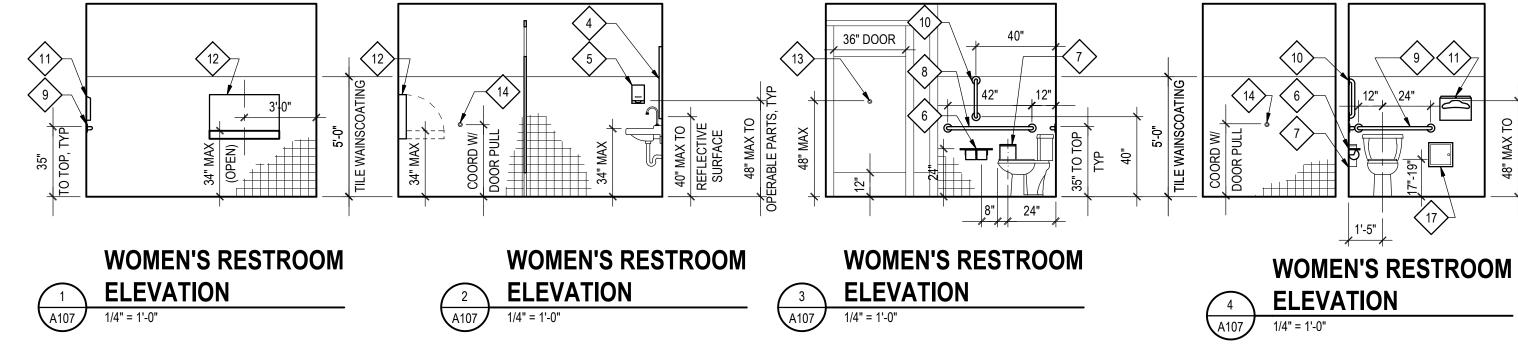

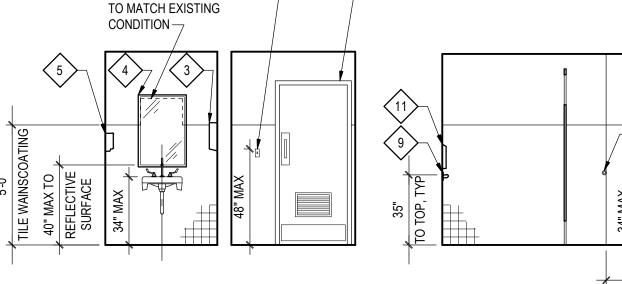

EXISTING DOOR & DOOR FRAME TO REMAIN -

WOMEN'S RESTROOM

MEN'S RESTROOM

ELEVATION


ELEVATION

RELOCATED LIGHT SWITCH —

EXISTING DOOR & DOOR FRAME TO REMAIN —


RELOCATED LIGHT SWITCH —

TILE BEHIND MIRROR

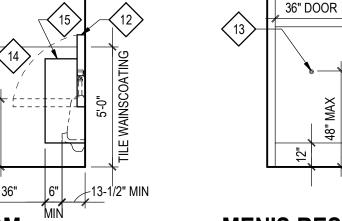



MEN'S RESTROOM **ELEVATION**

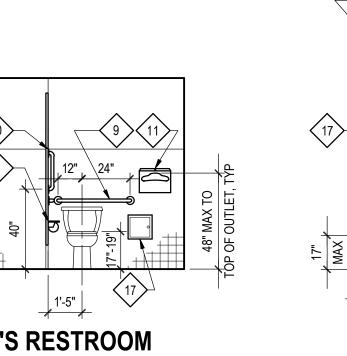

MEN'S RESTROOM 9 ELEVATION

TILE ABOVE WAINSCOATING TO MATCH EXISTING CONDITION TILE BEHIND MIRROR TO MATCH **EXISTING CONDITION**

MEN'S RESTROOM 10 ELEVATION





PAINT EXISTING CMU, PROVIDE FLOOR TILE & PROVIDE WALL TILE THROUGHOUT. PROVIDE TOILET PARTITIONS, WHERE INDICATED.

PROVIDE GFCI DUPLEX RECEPTACLE AT EXISTING BACK BOX.

PARTITION ABUTS EXISTING WALL IN THIS LOCATION

ALL FLOOR PENETRATIONS PER DETAIL 1/A108.

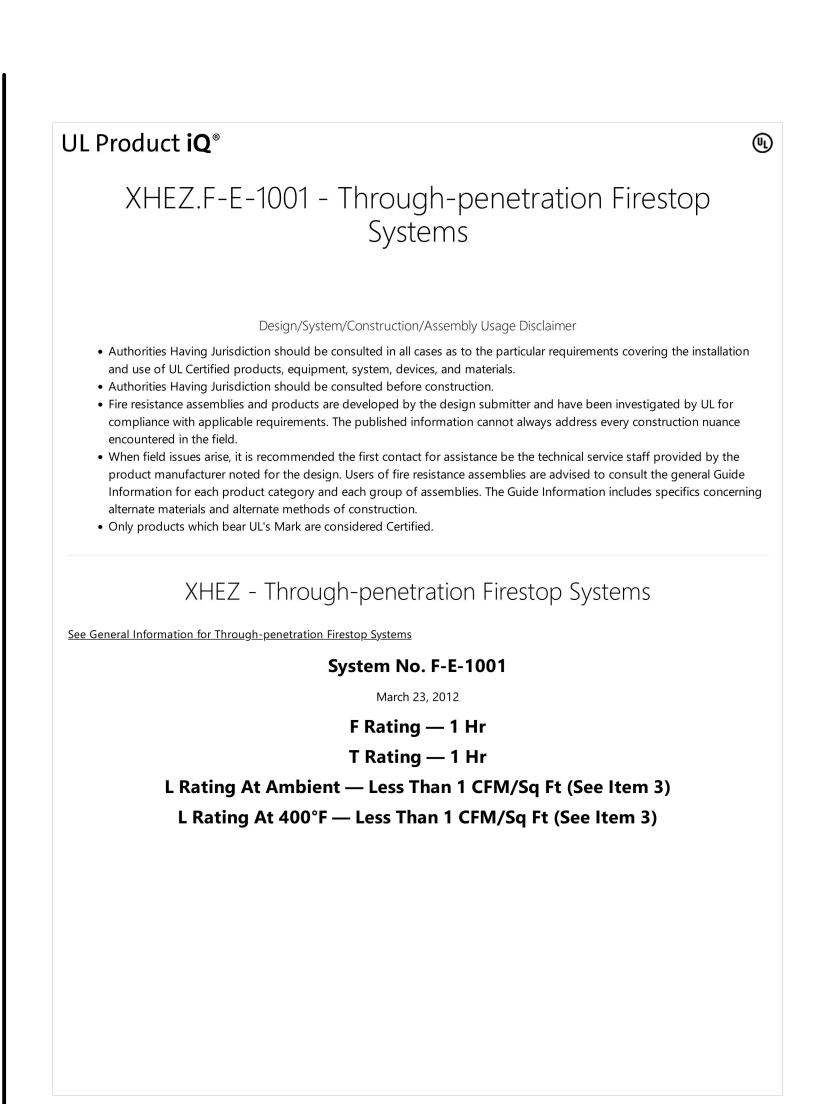

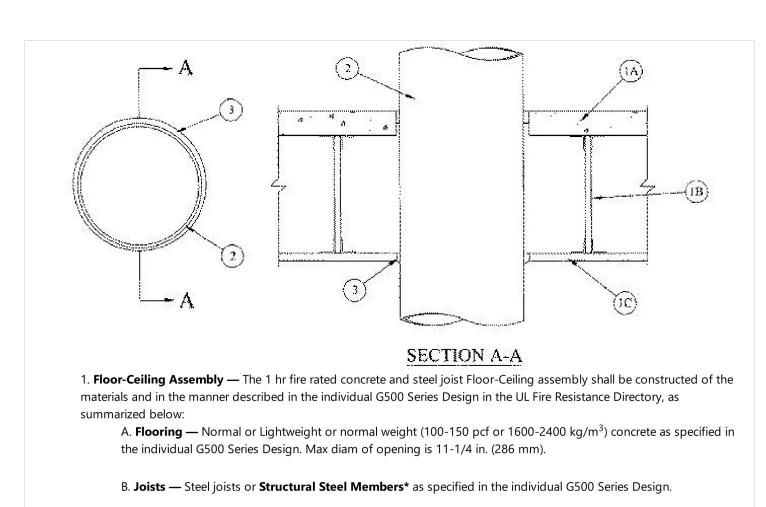

C. **Gypsum Board*** — Min 5/8 in. (16 mm) thick, screw-attached to furring channels as specified in the individual G500 Series Design. Max diam of opening is 11-1/4 in. (286 mm).

2. **Through Penetrant** — One metallic pipe, conduit or tubing to be installed either concentrically or eccentrically within the opening, approx midway between joists. The annular space between penetrant and periphery of opening shall be min 1/4 in. (6 mm) to max 1/2 in. (13 mm). Penetrant to be rigidly supported on both sides of floor assembly. The following types and sizes of metallic pipe, conduit or tubing may be used:

A. **Steel Pipe** — Nom 10 in. (254 mm) diam (or smaller) Schedule 10 (or heavier) steel pipe.

B. Iron Pipe — Nom 10 in. (254 mm) diam (or smaller) cast or ductile iron pipe.

C. **Conduit** — Nom 6 in. (152 mm) diam (or smaller) steel conduit, or nom 4 in. (102 mm) diam (or smaller) electrical metallic tubing.


D. **Copper Tubing** — Nom 3 in. (76 mm) diam (or smaller) Type L (or heavier) copper tube.

E. **Copper Pipe** — Nom 3 in. (76 mm) diam (or smaller) Regular (or heavier) copper pipe.

3. **Fill, Void or Cavity Materials*** — **Caulk or Sealant** — Min 3/4 in. (19 mm) thickness of fill material applied within the annulus, flush with top surface of floor. Min 5/8 in. (16 mm) thickness of fill material applied within the annulus, flush with bottom surface of ceiling. An additional min 1/4 in. (6 mm) crown of fill material applied to perimeter of penetrant at its egress from the underside of ceiling.

3M COMPANY — CP-25 WB+ Caulk, IC-15 WB+ Caulk or FB-3000 WT Sealant

(Note - L Rating applies only when CP 25 WB+ Caulk or FB-3000 WT Sealant is used.)

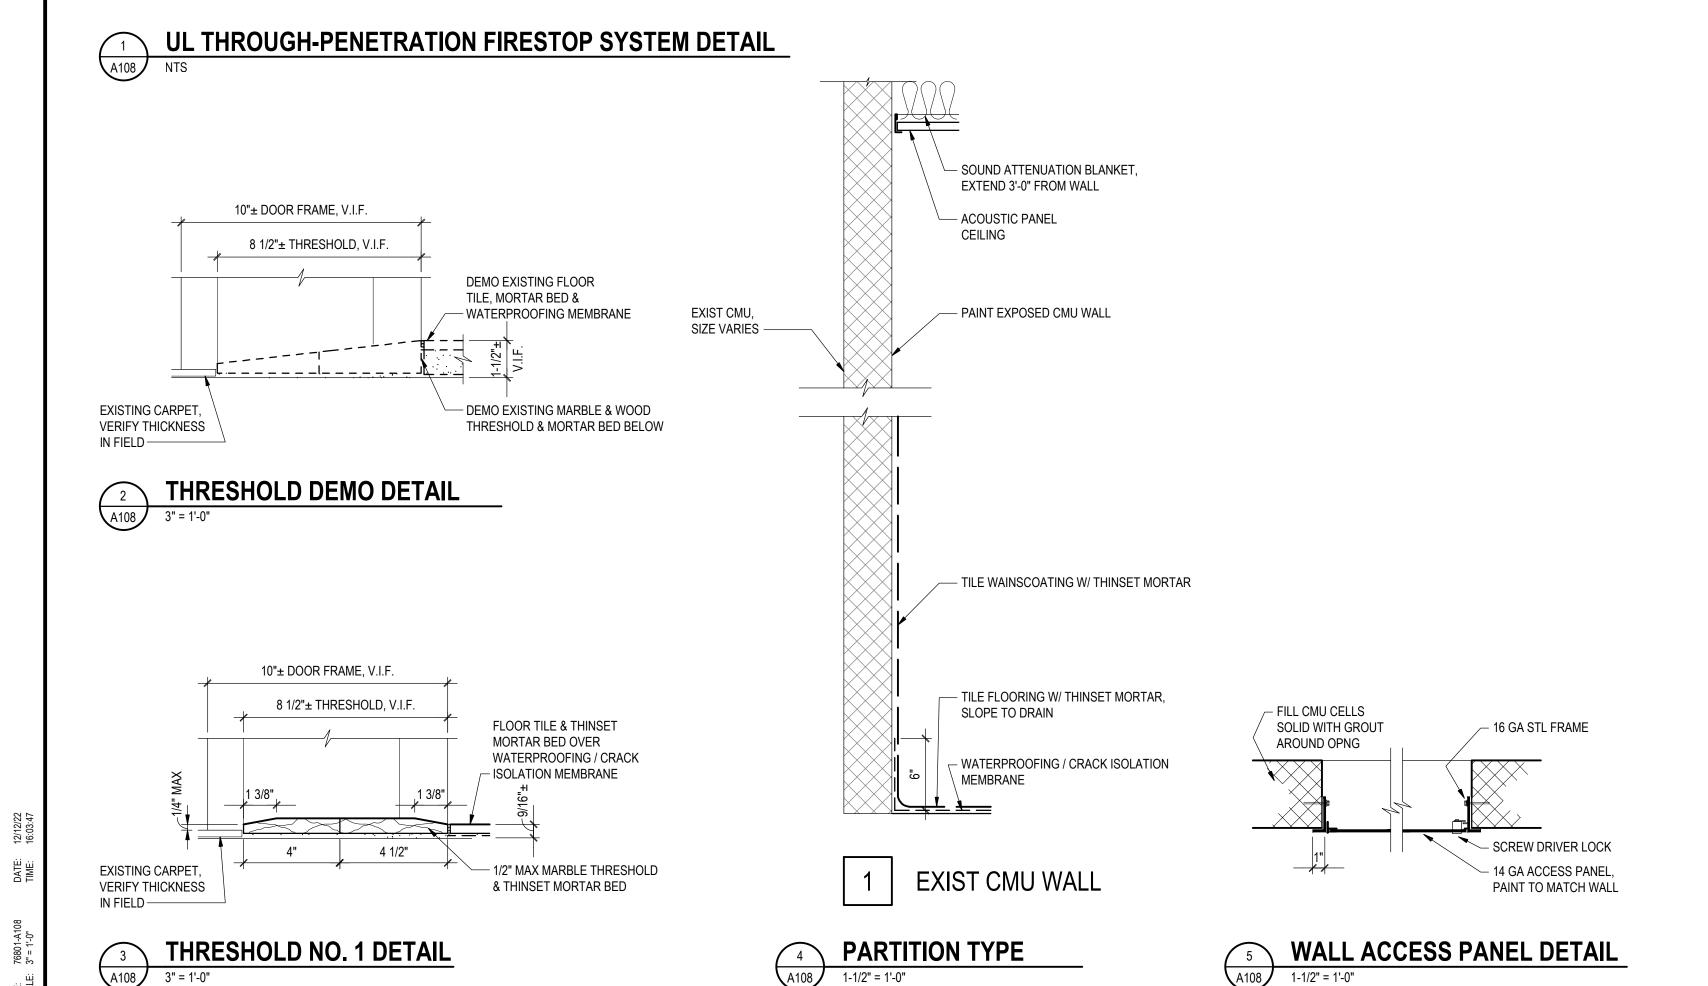

* Indicates such products shall bear the UL or cUL Certification Mark for jurisdictions employing the UL or cUL Certification (such as Canada), respectively.

<u>Last Updated</u> on 2012-03-23

The appearance of a company's name or product in this database does not in itself assure that products so identified have been manufactured under UL's Follow-Up Service. Only those products bearing the UL Mark should be considered to be Certified and covered under UL's Follow-Up Service. Always look for the Mark on the product.

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G A U T H I E R A L V A R A D O A S S O C I A T E S


703-241-2202 WWW.GAA-AE.COM

PROJECT TITLE

VIRGINIA DEPARTMENT OF TRANSPORTATION

State Project No. 501-B2501-012

PETERSBURG &
SOUTH HILL
RESIDENCY
RESTROOM
RENOVATIONS

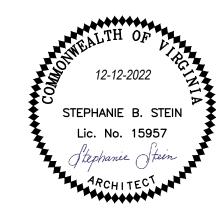

REVISIONS

NO. DATE DESCRIPTION

GAA PROJECT NO. 768-E1

CHECKED BY JH

DRAWING TITLE

DRAWN BY SS

ARCHITECTURAL
SOUTH HILL RESIDENCY
DETAILS

12-12-2022

PROJECT STATUS

PERMIT SUBMISSION

DRAWING NUMBER


A108

	PLUMBING FIXTURE SCHEDULE													
NO.	FIXTURE			VENT	CW	HW	COMMENTS							
WC	WATER CLOSET (<u>.</u>	4"	2"	1/2"	-	TANK TYPE, PRESSURE ASSISTED, 1.1 GPF. NOTE 2 & 4.							
UR	URINAL - HANDICAPPED		2"	1-1/2"	3/4"	-	0.125 GPF. MANUAL FLUSH VALVE. NOTE 2 & 4.							
LAV	LAVATORY - HANDICAPPED (5	1-1/2"	1-1/2"	1/2"	1/2"	PROVIDE TEMPERING VALVE. SEE NOTE 1 & 3.							
FD	FLOOR DRAIN		4"	2"	-	-	SQUARE FLOOR DRAIN. PROVIDE TRAP PRIMING VALVE.							

NOTES:

- 1. PROVIDE WATER TEMPERING VALVE CONFORMING TO ASSE 1070. ADJUST VALVE TO A MAXIMUM HOT WATER SUPPLY SETTING OF 109 DEG. F. SEE SPECIFICATIONS FOR MORE INFORMATION.
- 2. HANDICAP ACCESSIBLE FIXTURES SHALL BE LOCATED & MOUNTED IN ACCORDANCE WITH ARCHITECTURAL PLANS.
- 3. PROVIDE PROTECTIVE SHIELDING PIPE COVERS AND INSTALL TO MEET THE REQUIREMENTS OF THE AMERICANS
- WITH DISABILITIES ACT.
- 4. FLUSH VALVE/HANDLE SHALL BE ON THE ACCESSIBLE SIDE OF THE STALL.

PLUMBING SYMBOLS

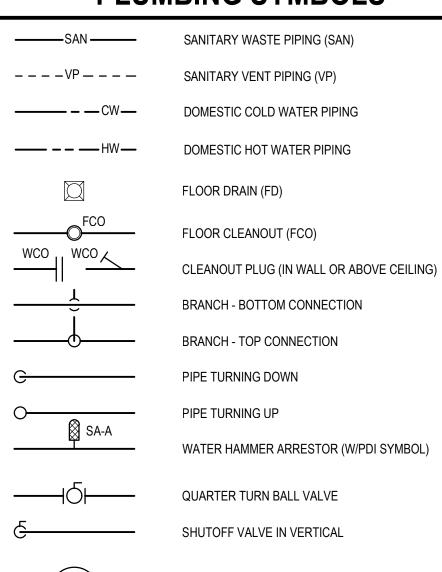

SANITARY VENT RISER INDICATOR

DOMESTIC WATER RISER INDICATOR

PLUMBING FIXTURE DESIGNATION

(DB)

PLUMBING ABBREVIATIONS

- A.S. AS SHOWN ABV ABOVE AFF ABOVE FINISHED FLOOR ARCH ARCHITECT AV ACID VENT AW ACID WASTE AW&V ACID WASTE & VENT BFP BACKFLOW PREVENTOR BLDG BUILDING BLW BELOW BTU BRITISH THERMAL UNIT BWV BACK WATER VALVE CA COMPRESSED AIR
 - CFH CUBIC FEET PER HOUR CFM CUBIC FEET PER MINUTE CI CAST IRON CLG CEILING CO CLEANOUT CONC CONCRETE COND CONDENSATE CONN CONNECTION COP CLEANOUT PLUG CW COLD WATER
 - DET DETAIL DF DRINKING FOUNTAIN DFU DRAINAGE FIXTURE UNITS DIA,D DIAMETER DN DOWN DWG DRAWING
 - (E) EXISTING EA EACH ELEV,EL ELEVATION EX EXISTING
 - EWC ELECTRIC WATER COOLER ECO EXTERIOR CLEAN OUT
 - FD FLOOR DRAIN FCO FLOOR CLEAN OUT FIN FINISHED FLR FLOOR FS FLOOR SINK FTG FITTING
 - FU FIXTURE UNITS (SUPPLY) GPM GALLONS PER MINUTE GPF GALLONS PER FLUSH
 - H HEIGHT HB HOSE BIBB HC HANDICAPPED HTR HEATER HW HOT WATER HWR HOT WATER RECIRCULATING

- IE INVERT ELEVATION INSUL INSULATION
- INV INVERT LAB LABORATORY
 - LAV LAVATORY LCW LAB COLD WATER LH&CW LAB HOT & COLD WATER LHW LAB HOT WATER LNTH LENGTH
 - LPG LIQUEFIED PETROLEUM GAS MB MOP BASIN MBH 1,000 BTU'S PER HOUR
 - MECH MECHANICAL MH MANHOLE MIN MINIMUM, MINUTE # NUMBER
 - N.C. NORMALLY CLOSED NIC NOT IN CONTRACT N.O. NORMALLY OPEN
 - OC ON CENTERS OFD OVERFLOW DRAIN OSD OPEN SITE DRAIN OW OILY WATER PRV PRESSURE REDUCING VALVE
- RAD REFRIGERATED AIR DRYER REC RECOVERY RECIRC. RECIRCULATION REQ'D REQUIRED

SAN SANITARY

- RPM REVOLUTIONS PER MINUTE RPP REDUCED PRESSURE PRINCIPAL SA SHOCK ABSORBER
- SF,|F SQUARE FEET SH SHOWER SK SINK
- SS SERVICE SINK/STAINLESS STEEL SW STORM WATER
- TEMP TEMPERATURE THRU THROUGH TP TRAP PRIMER TOT TOTAL TYP TYPICAL
- V VENT VIV VALVE IN VERTICAL VP VENT PIPE
- VTR VENT THRU ROOF W WIDTH, WASTE W/ WITH W/O WITHOUT
- WC WATER CLOSET WCO WALL CLEAN OUT WH WALL HYDRANT WT WEIGHT WTR WATER

PLUMBING GENERAL NOTES

NOTES APPLY TO ALL PLUMBING DRAWINGS.

- 1. ALL PLUMBING SERVICES AND EQUIPMENT SHALL BE FULLY COORDINATED WITH ALL TRADES PRIOR TO INSTALLATION.
- 2. PROVIDE INDIVIDUAL SHUTOFF VALVES FOR ALL PLUMBING FIXTURES. SHUTOFF VALVES FOR EACH FIXTURE SHALL BE ACCESSIBLE FROM SPACE. REFER TO FIXTURE SCHEDULES FOR SERVICES REQUIRED.
- 3. PROVIDE PIPING RUNOUTS TO ALL FIXTURES. MAKE FINAL CONNECTIONS OF ALL SERVICES REQUIRED AT EACH FIXTURE. PROVIDE COUPLERS, CONNECTORS, AND ADAPTERS NECESSARY FOR FINAL CONNECTION.
- 4. ALL PIPING PENETRATIONS THROUGH FLOOR SLAB AND WALL SHALL BE SLEEVED. SLEEVES SHALL BE SIZED ACCORDING TO PIPE SIZE/INSULATED PIPE SIZE THRU SLAB AND WALL.
- 5. MAINTAIN THE INTEGRITY OF BUILDING INSULATION MATERIALS WHERE PIPING PASSES THROUGH OR RUNS WITHIN INSULATED WALLS AND ADJACENT EXPOSED INSULATION. ALL PLUMBING SHALL BE RUN WITHIN THE INSULATED ELVELOPE WITH THE EXCEPTION OF UNDER FLOOR SANITARY PIPES.
- 6. ALL HORIZONTAL VENT PIPING SHALL BE PITCHED FOR DRAINAGE.
- 7. PROVIDE MISCELLANEOUS STEEL AS REQUIRED TO PROPERLY SUPPORT SUSPENDED PIPING AND EQUIPMENT. STEEL SHALL BE SUPPORTED FROM STRUCTURAL FRAMING MEMBERS.
- 8. SEE SYSTEM DIAGRAMS AND DETAILS FOR ADDITIONAL VALVES AND ACCESSORIES.
- 9. LOCATE AND SIZE PLUMBING EQUIPMENT CONCRETE PADS AND CURBS IN ACCORDANCE WITH ACTUAL EQUIPMENT PURCHASED.
- 10. PROVIDE ACCESS DOORS WHERE REQUIRED FOR ACCESS TO ALL SHUTOFF VALVES, WALL CLEANOUTS, AND WATER HAMMER ARRESTERS.
- 11. DO NOT RUN PIPING THROUGH OR ABOVE ELECTRICAL ROOMS.
- 12. COORDINATE ALL ELECTRICAL REQUIREMENTS OF PLUMBING
- 13. MAINTAIN CLEARANCE FROM ALL ELECTRICAL EQUIPMENT PER

EQUIPMENT WITH THE ELECTRICAL CONTRACTOR.

APPLICABLE CODES.

- PIPE SLEEVE

- FILL SPACE WITH

INTUMESCENT WRAP STRIP.

INSULATION, IF INSULATED

SEAL WITH SEALANT, 5/8" MIN, BOTH SIDES

- ESCUTCHEON PLATE IN

FINISHED AREAS

W/O INSUL

W/ INSUL

VERTICAL

- **SOUTH HILL** 14. APPLICABLE PLUMBING CODE: VIRGINIA PLUMBING CODE-2012. RESIDENCY
 - **RESTROOM RENOVATIONS**

GAUTHIER

ALVARADO

703-241-2202

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PROJECT TITLE

ASSOCIATES


VIRGINIA DEPARTMENT OF

TRANSPORTATION

State Project No.

501-B2501-012

PETERSBURG &

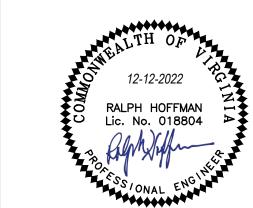

REVISIONS

NO. DATE DESCRIPTION GAA PROJECT NO. 768-E1 DRAWN BY JK

CHECKED BY RH 12-12-2022

DRAWING TITLE

PLUMBING COVER SHEET

PROJECT STATUS

PERMIT SUBMISSION

DRAWING NUMBER

IFB # 157389

FIRE RATED ASSEMBLIES SHALL BE 1". INTERIOR PIPE SLEEVE DETAIL NOT TO SCALE

HORIZONTAL

1. REFER TO ARCH DRAWINGS FOR BUILDING

2. COORDINATE LOCATION OF SLEEVE WITH BUILDING STRUCTURAL WORK PRIOR TO

INSULATED METAL PIPE, 4" OR LESS THAT

PENETRATES A FIRE RATED ASSEMBLY

6. SEALANTS ON PENETRATIONS OF 3 HOUR

SHALL FOLLOW UL SYSTEM NO. W-J-5037.


AND WALL SECTIONS AND DETAILS.

NOTES:


INSTALLATION.

3. SLEEVE SHALL BE PVC.

SEE LS102 FOR DETAILS.

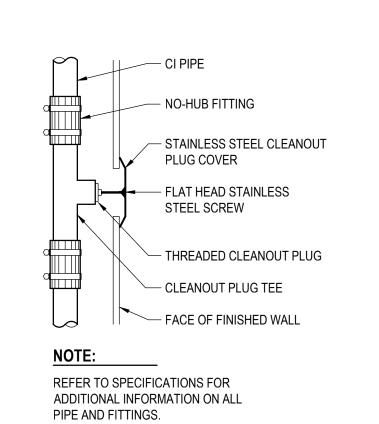

WALL CLEANOUT DETAIL NOT TO SCALE

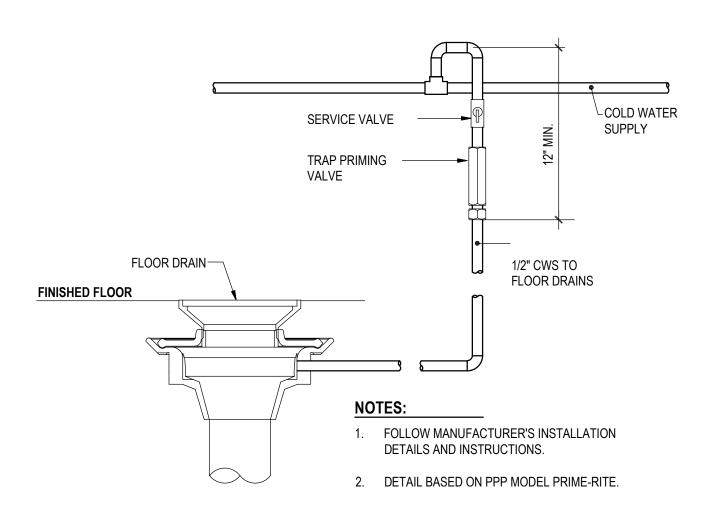

TRAP PRIMER DETAIL

NOT TO SCALE

DEMOLITION KEY NOTES

- 1 REMOVE EXISTING WATER CLOSET AND ALL ASSOCIATED COMPONENTS. REMOVE PORTION OF WASTE, VENT, DOMESTIC WATER PIPING TO POINT WHERE INDICATED. RETAIN PIPING AND REFER TO NEW WORK FOR RECONNECTION.
- 2 REMOVE EXISTING WATER CLOSET AND ALL ASSOCIATED COMPONENTS IN ITS ENTIRETY. PROVIDE FLOOR CLEANOUT ON WATER CLOSET ROUGH-IN. REMOVE DOMESTIC WATER PIPING BACK TO MAIN AND CAP.
- 3 REMOVE EXISTING URINAL, FLUSH VALVE, CARRIER, AND ALL ASSOCIATED COMPONENTS. PROVIDE WALL CLEANOUT ON URINAL ROUGH-IN. REMOVE DOMESTIC WATER PIPING BACK TO MAIN AND
- 4 REMOVE EXISTING LAVATORY AND ALL ASSOCIATED COMPONENTS INCLUDING FAUCET, P-TRAP, ANGLE STOPS, AND STAINLESS STEEL WATER SUPPLIES. RETAIN WASTE, VENT, AND WATER PIPING FOR NEW INSTALLATION.
- 5 REMOVE EXISTING LAVATORY AND ALL ASSOCIATED COMPONENTS IN ITS ENTIRETY. REMOVE SANITARY AND DOMESTIC WATER PIPING BACK TO MAIN AND CAP.
- 6 REMOVE AND RETAIN EXISTING LAVATORY AND ALL ASSOCIATED COMPONENTS FOR REINSTALLATION. REMOVE P-TRAP, ANGLE STOP, AND STAINLESS STEEL WATER SUPPLIES.


AREA OF WORK

PETERSBURG - KEY PLAN

NOT TO SCALE




- 1 INSTALL EXISTING WATER CLOSET IN THE LOCATION SHOWN.
 PROVIDE NEW ROUGH-IN AND CONNECT TO EXISTING SANITARY
 PIPE. PROVIDE NEW ANGLE STOP AND STAINLESS STEEL WATER
 SUPPLY
- 2 INSTALL WATER CLOSET IN THE LOCATION SHOWN. PROVIDE NEW ROUGH-IN AND CONNECT TO EXISTING SANITARY PIPE. PROVIDE NEW ANGLE STOP AND STAINLESS STEEL WATER SUPPLY.
- 3 PROVIDE FLOOR DRAIN IN THE LOCATION SHOWN.
- 4 EXTEND NEW DRAIN AND WATER PIPING TO NEW LAVATORY. PROVIDE NEW P-TRAP, ANGLE STOPS, AND STAINLESS STEEL WATER SUPPLIES.
- 5 REINSTALL EXISTING LAVATORY AND CONNECT NEW P-TRAP, ANGLE STOPS, AND STAINLESS STEEL WATER SUPPLIES.

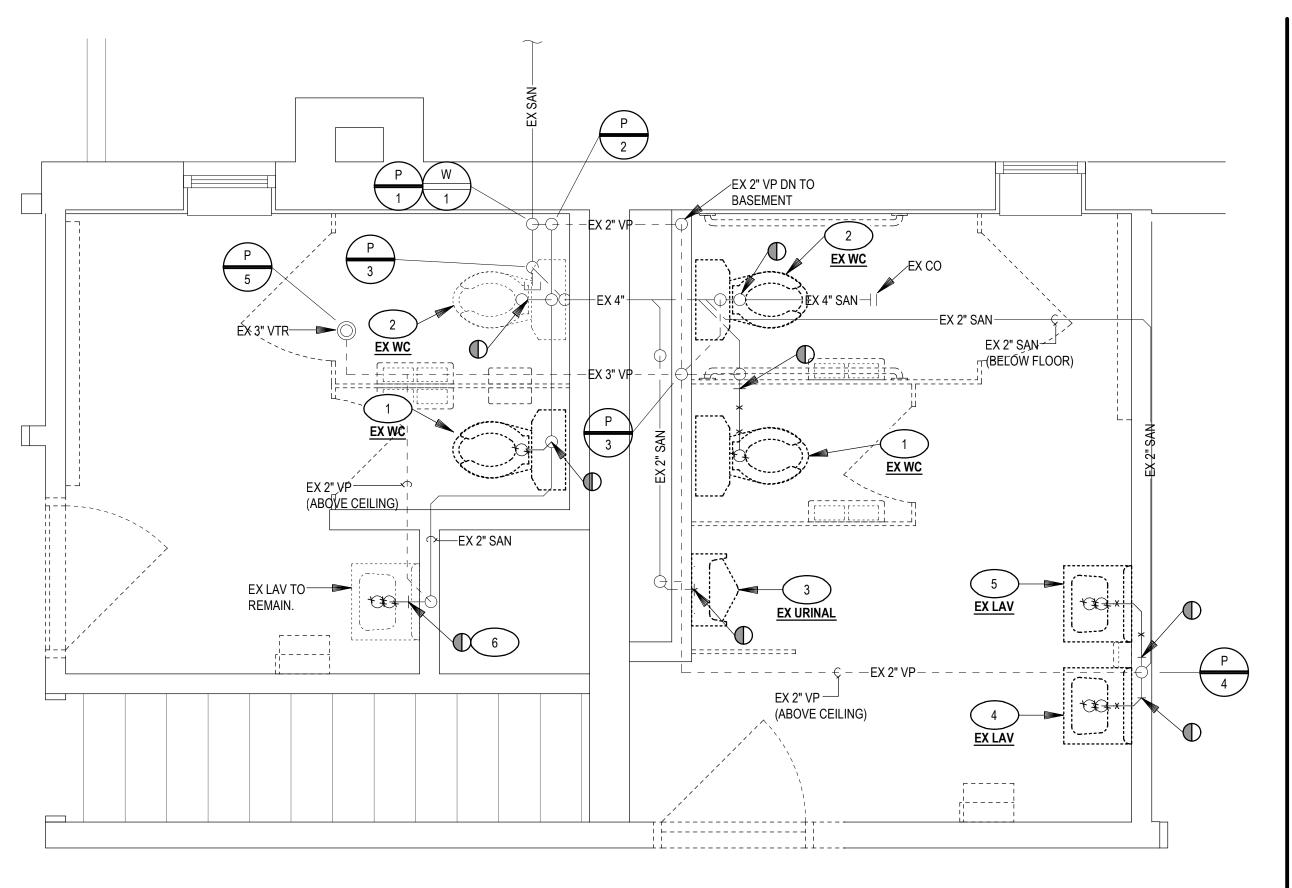

PETERSBURG - DEMOLITION FLOOR PLAN

1/2" = 1'-0"

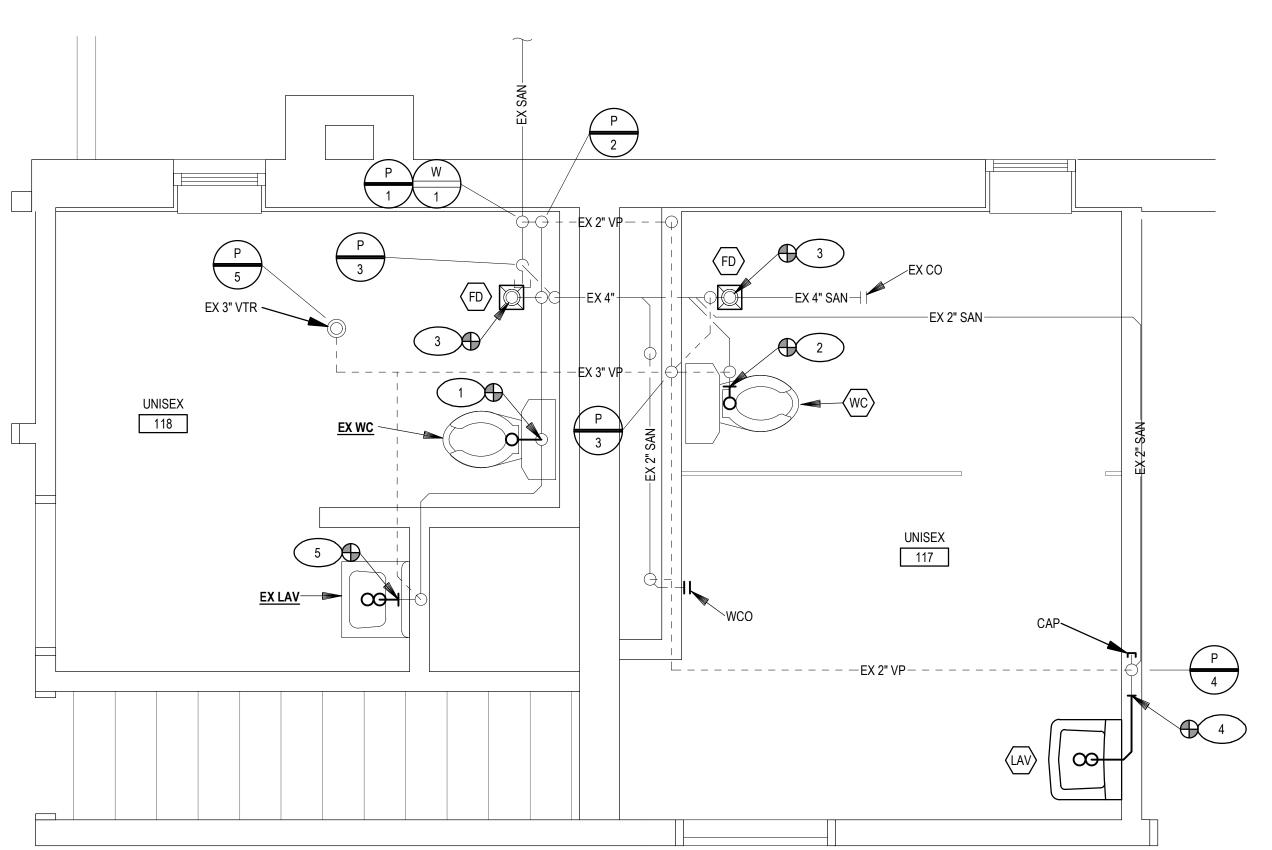

PETERSBURG - NEW WORK FLOOR PLAN

/2" = 1'-0"



G A U T H I E R A L V A R A D O A S S O C I A T E S


703-241-2202 WWW.GAA-AE.COM

PROJECT TITLE

VIRGINIA DEPARTMENT OF TRANSPORTATION

State Project No. 501-B2501-012

PETERSBURG &
SOUTH HILL
RESIDENCY
RESTROOM
RENOVATIONS

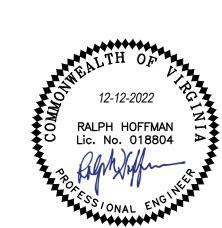

REVISIONS

NO. DATE DESCRIPTION

GAA PROJECT NO. 768-E1

DRAWN BY JK

CHECKED BY RH

DRAWING TITLE

PLUMBING
PETERSBURG - DEMOLITION &
NEW WORK FLOOR PLAN

12-12-2022

PROJECT STATUS

PERMIT SUBMISSION

DRAWING NUMBER

P101

DEMOLITION KEY NOTES

NEW WORK KEY NOTES

EXTEND NEW SANITARY DRAIN TO NEW ROUGH-IN LOCATION.

PROVIDE NEW ANGLE STOP AND STAINLESS STEEL WATER SUPPLY AND CONNECT TO NEW WATER CLOSET.

) CONNECT NEW LAVATORY TO EXISTING SANITARY AND DOMESTIC

WATER PIPING. PROVIDE NEW P-TRAP, ANGLE STOP, AND

) RECONNECT DOMESTIC WATER PIPE TO NEW FLUSH VALVE.

PROVIDE NEW FLOOR DRAIN IN THE LOCATION SHOWN. MATCH

STAINLESS STEEL WATER SUPPLIES.

EXISTING DRAIN SIZE.

REMOVE EXISTING WATER CLOSET AND ALL ASSOCIATED COMPONENTS. REMOVE PORTION OF WASTE PIPING INCLUDING ROUGH-IN. VENT AND DOMESTIC WATER PIPING TO REMAIN. ANGLE STOP AND STAINLESS STEEL WATER SUPPLY TO BE REPLACED. REFER TO NEW WORK FOR RECONNECTION.

EX 3" VTR

EX 4" SAN+++

EX 2" VP-

EX FCO

EX 3" ST, UP —

EX FCO TO REMAIN

EX 3" ST ____

EX 2" VP—

- REMOVE EXISTING WATER CLOSET AND ALL ASSOCIATED COMPONENTS IN ITS ENTIRETY. PROVIDE FLOOR NEW FLOOR DRAIN AT THE ROUGH-IN LOCATION. REMOVE DOMESTIC WATER PIPING BACK TO MAIN AND CAP.
- REMOVE EXISTING URINAL, FLUSH VALVE, CARRIER, AND ALL ASSOCIATED COMPONENTS. RETAIN ALL PIPING FOR NEW INSTALLATION.
- REMOVE EXISTING LAVATORY AND ALL ASSOCIATED COMPONENTS INCLUDING FAUCET, P-TRAP, ANGLE STOPS, AND STAINLESS STEEL WATER SUPPLIES. RETAIN ALL PIPING FOR NEW INSTALLATION.
- REMOVE EXISTING LAVATORY AND ALL ASSOCIATED COMPONENTS IN ITS ENTIRETY. PROVIDE WALL CLEANOUT AT ROUGH-IN LOCATION. REMOVE DOMESTIC WATER PIPING BACK TO MAIN AND

EX 1" CW, DN **SOUTH HILL - DEMOLITION FLOOR PLAN**

EX 4" SAN+

EX 4" SAN+


EX 2" VP

EX HW —

—EX CW — ____

—EX 1/2" HW, DN

EX 3" VP

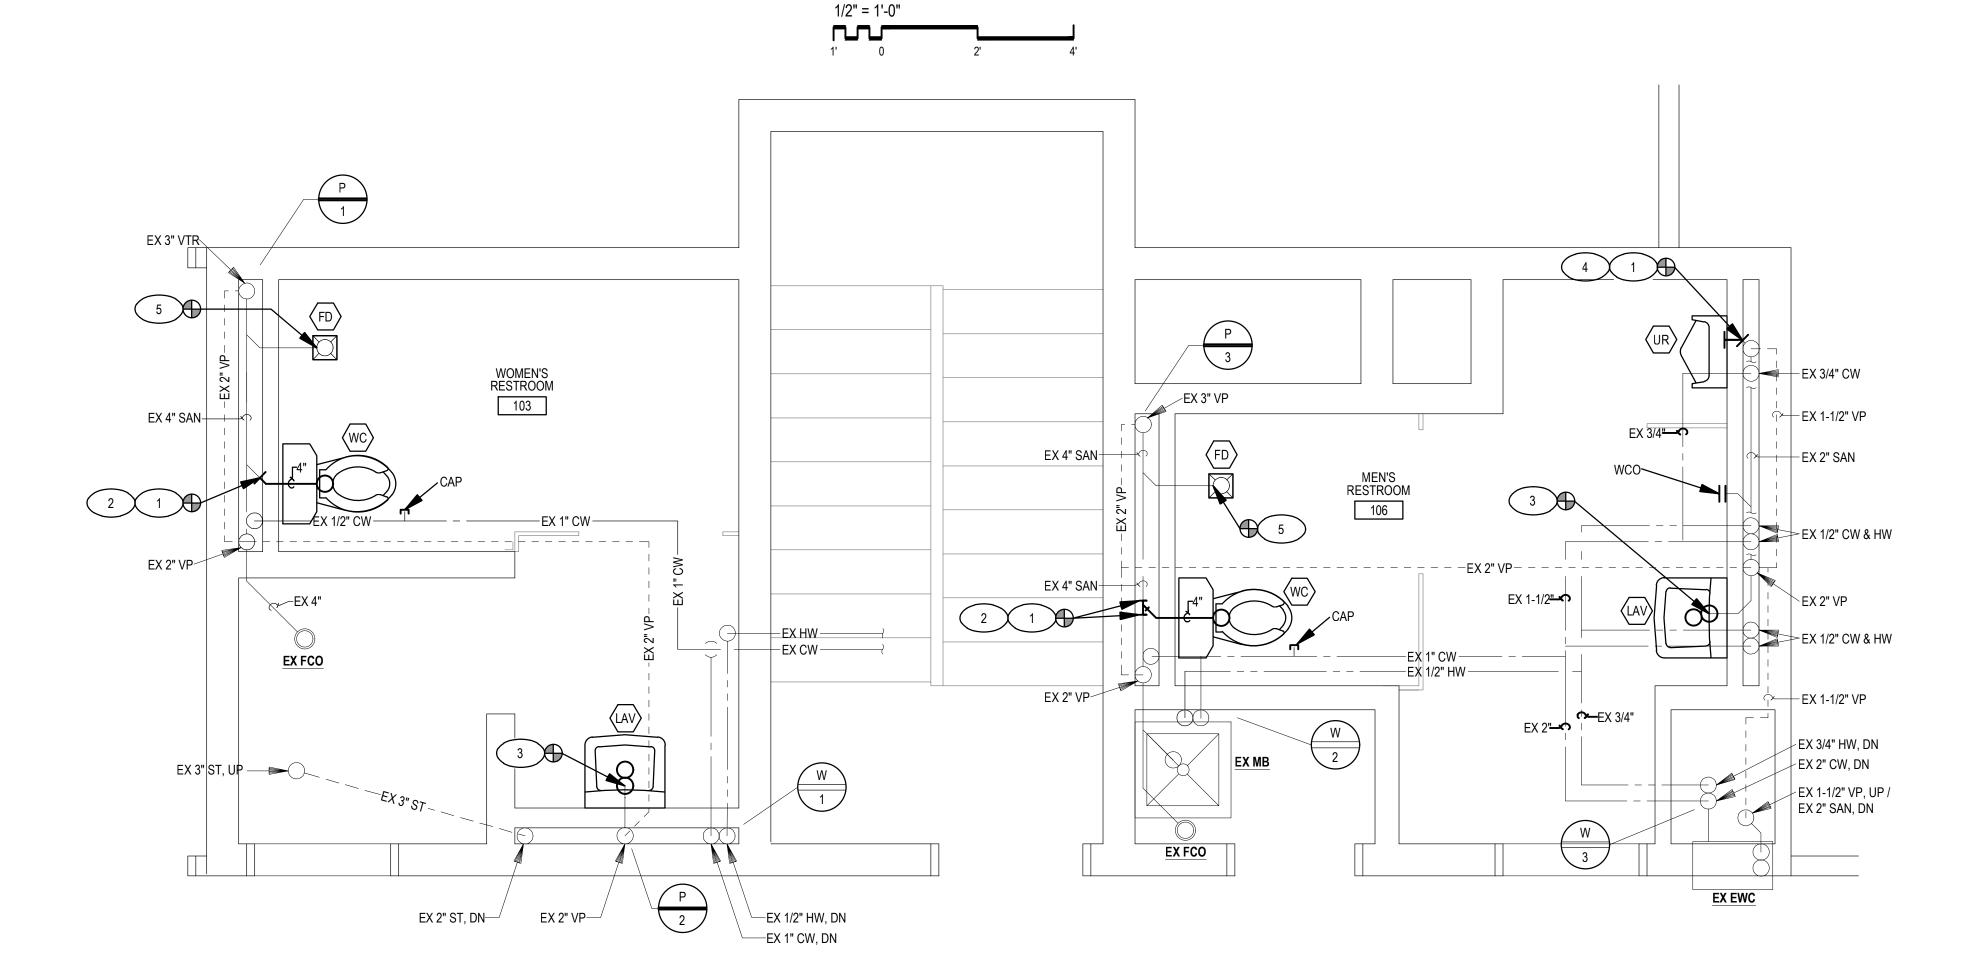

SOUTH HILL - NEW WORK FLOOR PLAN



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EX UR

EX LAV

EX LAV

EX 2"—

EX EWC TO REMAIN

EX 1-1/2"

– – ` – – – – EX 1/2" HW –

EX MB TO REMAIN

EX FCO TO REMAIN

EX 3/4" CW

← EX 1-1/2" VP

EX 1/2" CW & HW

EX 2" VP

Ŷ───EX 1-1/2" VP

EX 1/2" CW & HW

EX 3/4" HW, DN

EX 1-1/2" VP, UP / EX 2" SAN, DN


EX 2" CW, DN

PROJECT TITLE

VIRGINIA DEPARTMENT OF TRANSPORTATION

> State Project No. 501-B2501-012

PETERSBURG & **SOUTH HILL RESIDENCY RESTROOM RENOVATIONS**

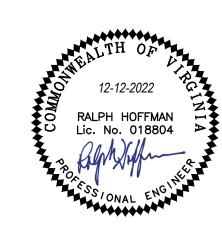

REVISIONS

NO. DATE DESCRIPTION

GAA PROJECT NO. 768-E1 DRAWN BY JK CHECKED BY RH 12-12-2022

DRAWING TITLE

PLUMBING SOUTH HILL - DEMOLITION &


NEW WORK FLOOR PLAN

PROJECT STATUS

PERMIT SUBMISSION

DRAWING NUMBER

P102

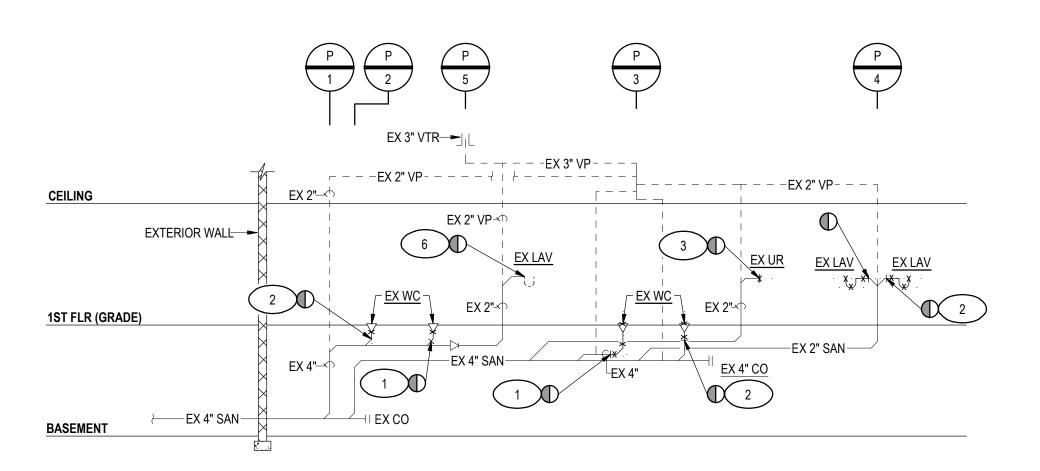


PETERSBURG - DEMOLITION SANITARY RISER DIAGRAM

NOT TO SCALE

EX 3" VTR—— EX 3" VTR—— EX 2" VP—— EX 2

PETERSBURG - NEW WORK SANITARY RISER DIAGRAM

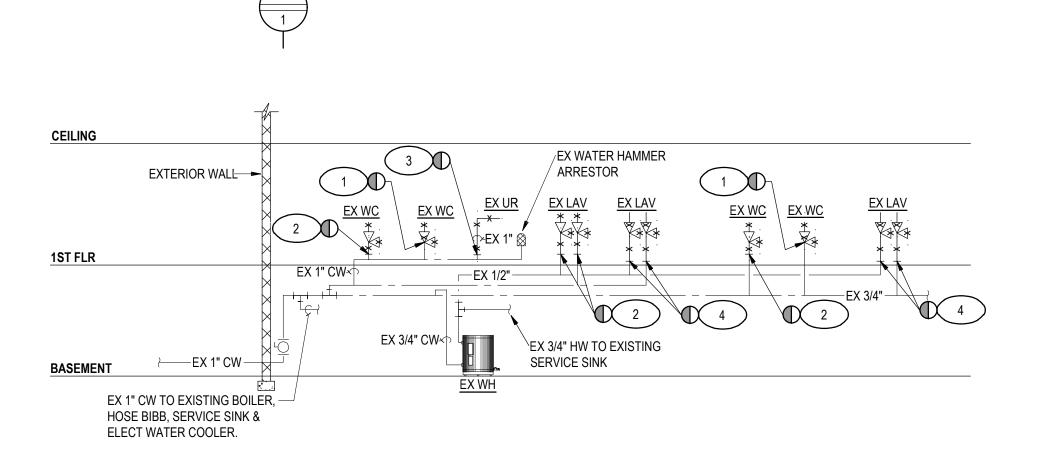

PETERSBURG - DEMOLITION WATER RISER DIAGRAM

NOT TO SCALE

COMPONENTS IN ITS ENTIRETY. REMOVE DOMESTIC WATER PIPING TO POINT WHERE INDICATED. RETAIN DRAIN ROUGH-IN FOR NEW INSTALLATION. VENT PIPING TO REMAIN.

3 REMOVING EXISTING URINAL, FLUSH VALVE, CARRIER, AND ALL ASSOCIATED COMPONENTS. REMOVE DOMESTIC WATER PIPING BACK TO MAIN AND CAP. PROVIDE WALL CLEANOUT ON URINAL ROUGH-IN. WASTE AND VENT PIPING TO REMAIN.

4 REMOVE EXISTING LAVATORY AND ALL ASSOCIATED COMPONENTS INCLUDING FAUCET, P-TRAP, ANGLE STOPS, AND STAINLESS STEEL WATER SUPPLIES. RETAIN WASTE, VENT, AND WATER PIPING FOR NEW INSTALLATION.

5 REMOVE EXISTING LAVATORY AND ALL ASSOCIATED COMPONENTS

REMOVE EXISTING WATER CLOSET AND ALL ASSOCIATED

2) REMOVE EXISTING WATER CLOSET AND ALL ASSOCIATED

ROUGH-IN. VENT AND DOMESTIC WATER PIPING TO REMAIN. ANGLE STOP AND STAINLESS STEEL WATER SUPPLY TO BE


COMPONENTS. REMOVE PORTION OF WASTE PIPING INCLUDING

DEMOLITION KEY NOTES

REPLACED.

5 REMOVE EXISTING LAVATORY AND ALL ASSOCIATED COMPONENTS IN ITS ENTIRETY. PROVIDE WALL CLEANOUT AT ROUGH-IN LOCATION. REMOVE DOMESTIC WATER PIPING BACK TO MAIN AND CAP.

6 REMOVE AND RETAIN EXISTING LAVATORY AND ALL ASSOCIATED COMPONENTS FOR REINSTALLATION. REMOVE P-TRAP, ANGLE STOP, AND STAINLESS STEEL WATER SUPPLIES.

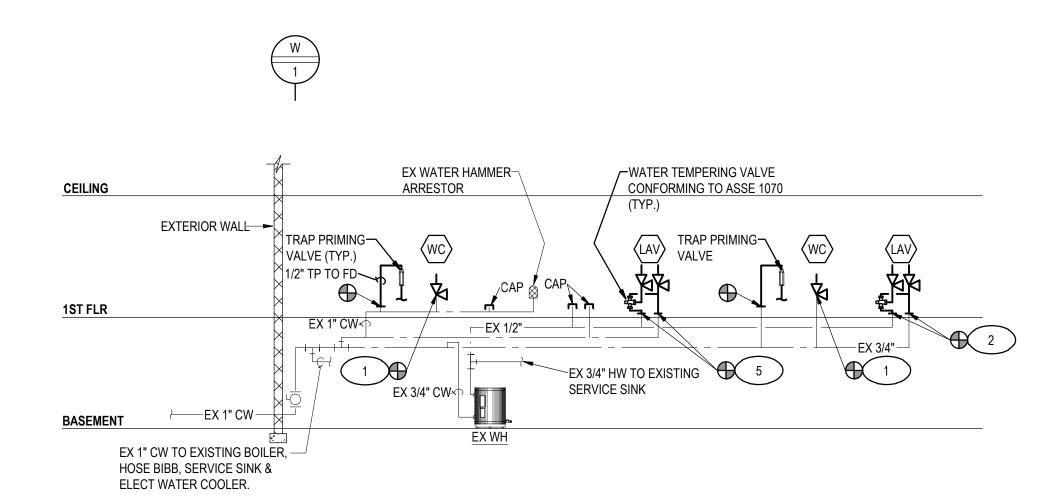

PETERSBURG - NEW WORK WATER RISER DIAGRAM

1 EXTEND NEW SANITARY DRAIN TO NEW ROUGH-IN LOCATION.
MATCH EXISTING DRAIN SIZE. PROVIDE NEW ANGLE STOP AND
STAINLESS STEEL WATER SUPPLY.

2 CONNECT NEW LAVATORY TO EXISTING DRAIN AND WATER PIPING.
PROVIDE NEW P-TRAP, ANGLE STOP, AND STAINLESS STEEL
WATER SUPPLIES.

3 NOT USED.

4 PROVIDE NEW FLOOR DRAIN IN THE LOCATION SHOWN.

5 REINSTALL EXISTING LAVATORY AND CONNECT NEW P-TRAP,
ANGLE STOP, AND STAINLESS STEEL WATER SUPPLIES.



PROJECT TITLE


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State Project No. 501-B2501-012

PETERSBURG &
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RESTROOM
RENOVATIONS



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CHECKED BY RH

DATE 12-12-2022

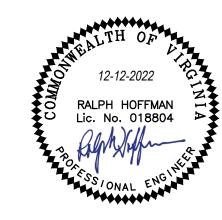DRAWING TITLE


PLUMBING
PETERSBURG - RISER
DIAGRAMS

PROJECT STATUS

PERMIT SUBMISSION

DRAWING NUMBER

P301

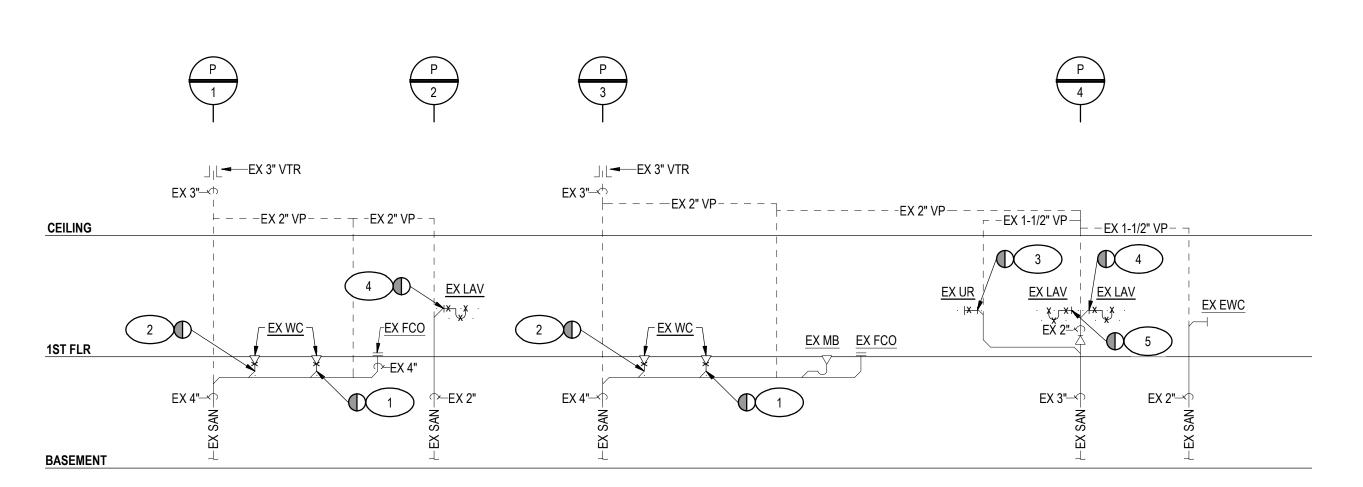

CEILING EX EWC *<u>EX WC</u> × EX 3/4"-EX 2" **BASEMENT**

SOUTH HILL - DEMOLITION SANITARY RISER DIAGRAM NOT TO SCALE

DEMOLITION KEY NOTES

REMOVE EXISTING WATER CLOSET AND ALL ASSOCIATED COMPONENTS. REMOVE PORTION OF WASTE PIPING INCLUDING ROUGH-IN. VENT AND DOMESTIC WATER PIPING TO REMAIN. ANGLE STOP AND STAINLESS STEEL WATER SUPPLY TO BE REPLACED.

2) REMOVE EXISTING WATER CLOSET AND ALL ASSOCIATED COMPONENTS IN ITS ENTIRETY. REMOVE DOMESTIC WATER PIPING BACK TO MAIN AND CAP. VENT PIPING TO REMAIN.


3) REMOVING EXISTING URINAL, FLUSH VALVE, CARRIER, AND ALL ASSOCIATED COMPONENTS. RETAIN WASTE, VENT, AND WATER PIPING FOR NEW INSTALLATION.


4) REMOVE EXISTING LAVATORY AND ALL ASSOCIATED COMPONENTS INCLUDING FAUCET, P-TRAP, ANGLE STOPS, AND STAINLESS STEEL WATER SUPPLIES. RETAIN WASTE, VENT, AND WATER PIPING FOR NEW INSTALLATION.

5 REMOVE EXISTING LAVATORY AND ALL ASSOCIATED COMPONENTS IN ITS ENTIRETY. PROVIDE WALL CLEANOUT AT ROUGH-IN LOCATION. REMOVE DOMESTIC WATER PIPING BACK TO MAIN AND

SOUTH HILL - DEMOLITION WATER RISER DIAGRAM

NOT TO SCALE

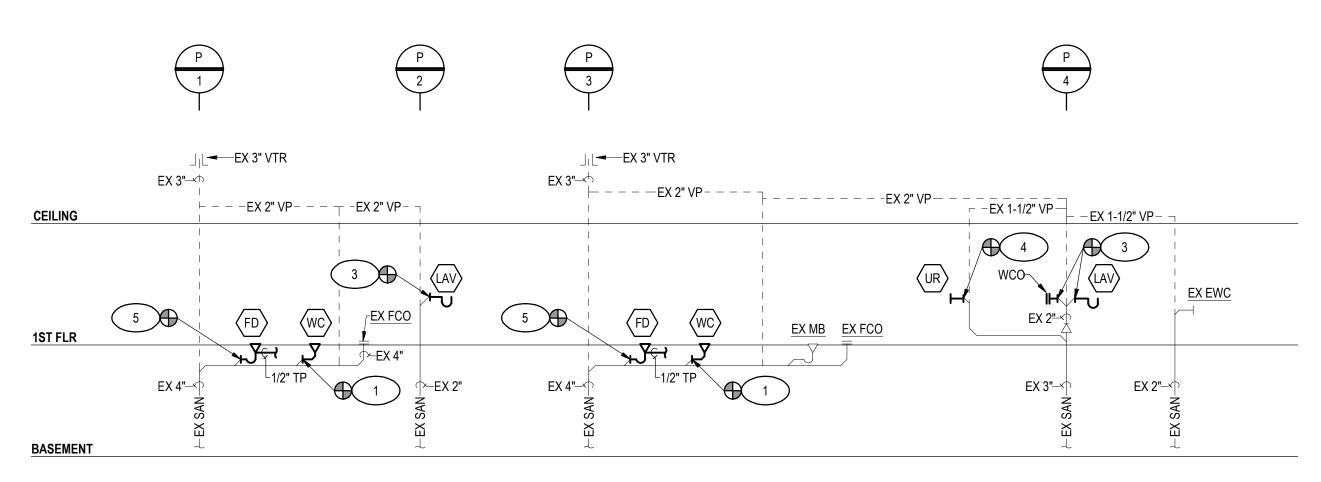

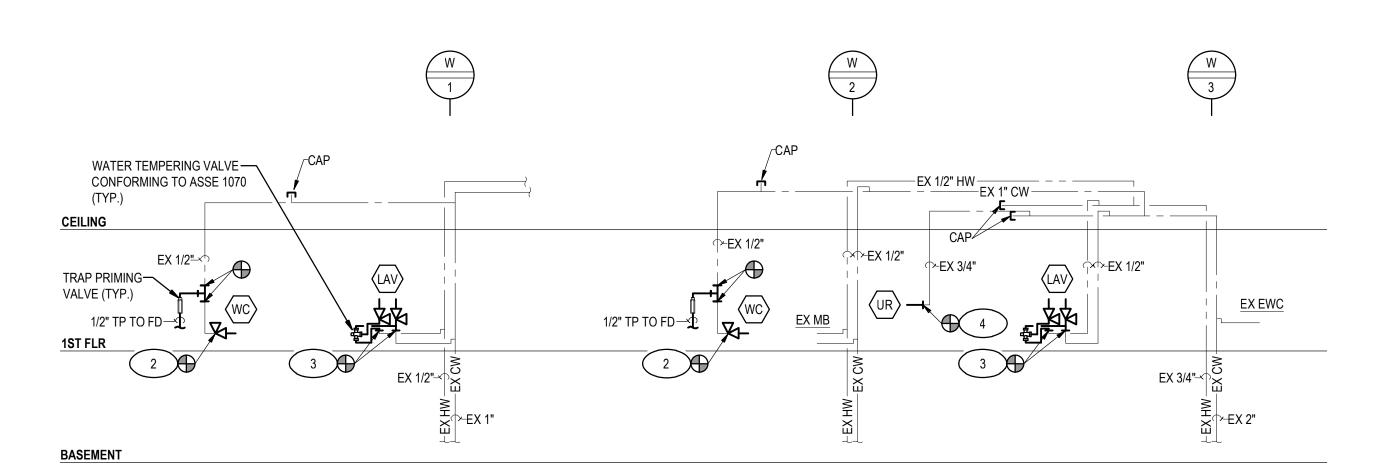

SOUTH HILL - NEW WORK SANITARY RISER DIAGRAM NOT TO SCALE

NEW WORK KEY NOTES

1 EXTEND NEW SANITARY DRAIN TO NEW ROUGH-IN LOCATION. MATCH EXISTING DRAIN SIZE.

2 PROVIDE NEW ANGLE STOP AND STAINLESS STEEL WATER SUPPLY AND CONNECT TO NEW WATER CLOSET.

3 CONNECT NEW LAVATORY TO EXISTING DRAIN AND WATER PIPING. PROVIDE NEW P-TRAP, ANGLE STOP, AND STAINLESS STEEL WATER SUPPLIES.

4) RECONNECT DRAIN AND DOMESTIC WATER PIPING TO URINAL. 5 PROVIDE NEW FLOOR DRAIN IN THE LOCATION SHOWN.

SOUTH HILL - NEW WORK WATER RISER DIAGRAM

GAUTHIER ALVARADO ASSOCIATES 703-241-2202


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> State Project No. 501-B2501-012

PETERSBURG & **SOUTH HILL RESIDENCY** RESTROOM **RENOVATIONS**



REVISIONS

NO. DATE DESCRIPTION

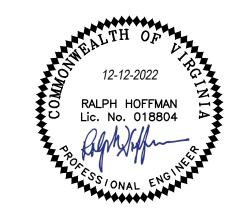GAA PROJECT NO. 768-E1 DRAWN BY JK CHECKED BY RH 12-12-2022

DRAWING TITLE

PLUMBING

SOUTH HILL - RISER DIAGRAMS

PROJECT STATUS

PERMIT SUBMISSION

DRAWING NUMBER

P302

MECHANICAL ABBREVIATIONS

ANGLE @ AT ABV ABOVE AD ACCESS DOOR MER MECHANICAL EQUIPMENT ROOM AFD ADJUSTABLE FREQUENCY DRIVE AFF ABOVE FINISH FLOOR AFMS AIRFLOW METERING STATION AHU AIR HANDLING UNIT ARCH. ARCHITECT MUW MAKE UP WATER A.S. AS SHOWN AUX AUXILIARY BD BACKDRAFT DAMPER BFP BACKFLOW PREVENTER BLDG BUILDING BLW BELOW NTS NOT TO SCALE BOT BOTTOM BTU BRITISH THERMAL UNIT BV BRICK VENT BWV BACK WATER VALVE CD CEILING DIFFUSER CEF CEILING EXHAUST FAN CFH CUBIC FEET PER HOUR CFM,C,IM CUBIC FEET PER MINUTE CG CEILING GRILLE CI CAST IRON CLG CEILING CO CLEANOUT PLUG CONC CONCRETE COND CONDENSATE CONN CONNECTION CR CEILING RETURN CUH CABINET UNIT HEATER CV CONTROL VALVE dB DECIBELS DB DRY BULB DBL DOUBLE DDC DIRECT DIGITAL CONTROL DESIG DESIGNATION DET DETAIL DIA DIAMETER DIM DIMENSION DN DOWN DWG DRAWING

EA EACH

EAT ENTERING AIR TEMPERATURE EER ENERGY EFFICIENCY RATIO EL, ELEV ELEVATION EQ EQUAL EQUIP. EQUIPMENT ER EXHAUST REGISTER ESP EXTERNAL STATIC PRESSURE

EWT ENTERING WATER TEMPERATURE EXH EXHAUST EX EXISTING EF EXHAUST FAN FAHRENHEIT

FC FLEXIBLE CONNECTION FCU FAN COIL UNIT FD FIRE DAMPER, FLOOR DRAIN FIN. FINISH (ED) FL FLOOR; FULL LENGTH

FLEX. FLEXIBLE FPM FEET PER MINUTE FPT FAN POWERED TERMINAL UNIT FT FOOT, FEET FTG FITTING FTR FLUE THRU ROOF

G GUIDE GAL GALLON GPM GALLONS PER MINUTE

FV FACE VELOCITY

H HEIGHT HTR HEATER HOA HAND-ON-AUTOMATIC HPG HIGH PRESSURE GAS HP HORSEPOWER HVAC HEATING, VENTILATING & AIR CONDITIONING

IN. INCH (ES) INV INVERT

LAT LEAVING AIR TEMPERATURE LAV LAVATORY LBS POUNDS LBS/HR POUNDS PER HOUR LG LONG; LENGTH LPG LIQUID PETROLEUM GAS

MAX MAXIMUM

MBH THOUSAND BTU PER HOUR MECH MECHANICAL

MFR MANUFACTURER MHP MOTOR HORSEPOWER MOD MOTOR OPERATED DAMPER

N/A NOT APPLICABLE NC NOISE CRITERION, NORMALLY CLOSED NIC NOT IN CONTRACT NO.,# NUMBER, NORMALLY OPEN

O OPEN 0A OUTSIDE AIR OAC OPEN ABOVE CEILING (IN WALL) OAL OUTSIDE AIR INTAKE

LOUVER OC ON CENTER OBD OPPOSED BLADE DAMPER OED OPEN END DUCT W/ 1/2" WIRE MESH

OD OUTSIDE DIAMETER PCF POUNDS PER CUBIC FOOT PE PIPE ENCLOSURE

PRESS. PRESSURE PRV PRESSURE REDUCING VALVE PSF POUNDS PER SQUARE FOOT PSI POUNDS PER SQUARE INCH PSIG POUNDS PER SQUARE INCH GAUGE

R RADIUS; RISER REC RECOVERY REG REGISTER REQD REQUIRED RPM REVOLUTIONS PER MINUTE RR RETURN REGISTER

SA SHOCK ABSORBER SD DUCT SMOKE DETECTOR SF SQUARE FEET SF SUPPLY FAN SR SUPPLY REGISTER

SS STAINLESS STEEL TEMP TEMPERATURE; TEMPORARY TG TRANSFER GRILLE TJW THRU JOIST WEB TOC TOP OF CONCRETE

TYP TYPICAL TU TERMINAL UNIT UBJ UP BETWEEN JOIST SPACE

UH UNIT HEATER UKN UNKNOWN UTR UP THRU ROOF UV UNIT VENTILATION

V VENT VAV VARIABLE AIR VOLUME TERMINAL VENT VENTILATION VFD VARIABLE FREQUENCY DRIVE

VIV VALVE IN VERTICAL VP VENT PIPE VTR VENT THRU ROOF

W WIDTH W/ WITH W/O WITHOUT WB WET BULB WCO WALL CLEANOUT WF WALL FIN WG WATER GAUGE WT WEIGHT

WTR,H|_2|-0 WATER

MECHANICAL NOTES:

1. GENERAL

A. THESE DRAWINGS ARE SCHEMATIC AND INTENDED TO DEPICT THE GENERAL LOCATION OF HVAC SYSTEM COMPONENTS IN ACCORDANCE WITH DRAWINGS, NOTES, AND THE INTENT OF THE DESIGN.

DRAWINGS ARE SCHEMATIC. THIS CONTRACTOR IS RESPONSIBLE TO COORDINATE HIS WORK WITH ACTUAL FIELD CONDITIONS AND OTHER TRADES.

C. THE INTENT OF THESE DRAWINGS IS TO PROVIDE COMPLETE AN PROPERLY FUNCTIONING HVAC SYSTEMS. PROVIDE ALL LABOR AND MATERIAL NECESSARY TO ACHIEVE SUCH ENDS.

CODES AND PERMITS: COMPLY WITH CODES, LAWS AND ORDINANCES IN FORCE AT BUILDING. SECURE AND PAY FOR PERMITS AND INSPECTION FEES REQUIRED FOR FULFILLING REQUIREMENTS OF THESE SPECIFICATIONS.

SUBSTITUTION OF EQUIPMENT AND MATERIALS: DRAWINGS ARE BASED UPON THE MANUFACTURER LISTED FIRST IN THE SCHEDULES. WHERE ANY OTHER EQUIPMENT IS USED, THIS CONTRACTOR WILL BE RESPONSIBLE FOR ANY CHANGES IN THE PLUMBING AND HVAC SYSTEM IN THE BUILDING DUE TO PHYSICAL LIMITATIONS OF SUCH EQUIPMENT, AND SHALL PAY FOR ALL GENERAL, STRUCTURAL, MECHANICAL AND ELECTRICAL CHANGES REQUIRED BY THE SUBSTITUTION. THIS CONTRACTOR SHALL INFORM ALL CONTRACTORS OF ANY CHANGES BEFORE THEY BEGIN THEIR RESPECTIVE WORK.

SLEEVES, OPENINGS, CUTTING AND DRILLING: CONTRACTOR SHALL PROVIDE AND PATCH ALL DUCT AND PIPING OPENINGS REQUIRED IN NEW CONSTRUCTION. MAKE ARRANGEMENTS WITH ALL OTHER CONTRACTORS FOR SPECIAL SLEEVES, FRAMING, SPACING AND CHASES. PROVIDE OPENINGS IN BUILDING CONSTRUCTION FOR PASSAGE OF PIPING AND DUCTWORK. DO NOT PENETRATE STRUCTURAL MEMBERS WITHOUT PRIOR WRITTEN APPROVAL OF BUILDING ENGINEER.

ALL NECESSARY ALLOWANCES AND PROVISIONS SHALL BE MADE BY THIS CONTRACTOR FOR BEAMS, COLUMNS OR OTHER OBSTRUCTIONS OF THE BUILDING OR THE WORK OF OTHER CONTRACTORS, WHETHER OR NOT SAME IS INDICATED. WHERE NECESSARY TO AVOID OBSTRUCTIONS THE DUCTS SHALL BE TRANSFORMED, DIVIDED, OFFSET, RAISED OR LOWERED WITH THE REQUIRED FREE AREA BEING MAINTAINED.

THE CONTRACTOR SHALL COORDINATE THE INSTALLATION OF HVAC AND PLUMBING WORK WITH EXISTING CONDITIONS AND THE WORK OF OTHER TRADES. MINOR DEVIATIONS FROM THE PLANS MAY BE MADE TO AVOID MINOR CONFLICTS. WHEN MAJOR CONFLICTS ARE APPARENT, THE OWNER SHALL BE ADVISED IMMEDIATELY, AND AFFECTED WORK SHALL NOT BE INSTALLED UNTIL THE CONFLICT HAS BEEN RESOLVED.

THE CONTRACTOR SHALL THOROUGHLY CLEAN HIS WORK AREA DAILY OR AS REQUESTED BY THE GENERAL CONTRACTOR. MECHANICAL CONTRACTOR SHALL ALSO REMOVE ALL HIS TRASH AND DEBRIS AFTER THE COMPLETION OF THE WORK.

8. ELECTRICAL WORK

A. ALL LINE VOLTAGE WIRING FOR HVAC EQUIPMENT, FACTORY-MOUNTED CONTROL PANELS AND TO INDIVIDUALLY MOUNTED STARTERS. AND FROM STARTERS TO MOTORS, SHALL BE PROVIDED BY THE ELECTRICAL CONTRACTOR. THIS CONTRACTOR SHALL TURN OVER ALL INDIVIDUALLY MOUNTED STARTERS AND DISCONNECT SWITCHES FURNISHED UNDER THIS CONTRACT TO THE ELECTRICAL CONTRACTOR FOR INSTALLATION BY HIM.

ALL LINE, OR LOW VOLTAGE, WIRING REQUIRED FOR TEMPERATURE CONTROL SHALL BE PROVIDED BY HVAC CONTRACTOR.

WIRING AND ELECTRICAL WORK SHALL COMPLY WITH THE NATIONAL ELECTRICAL CODE AND LOCAL REQUIREMENT.

9. TESTS

ADJUST ALL FAN DRIVES, AND AIR DISTRIBUTION DEVICES TO PROVIDE THE REQUIRED AIR QUANTITIES AS SHOWN ON THE DRAWINGS WITHIN +10% TO -5%

10. DUCTWORK PROVIDE AIR TURNING DEVICES IN DUCTWORK AT ANY CHANGES IN

ALL DUCTWORK SHALL BE SUSPENDED FROM THE BUILDING STRUCTURE IN ACCORDANCE WITH THE SMACNA DUCT CONSTRUCTION STANDARDS.

DIMENSIONS SHOWN ON DRAWINGS ARE INSIDE CLEAR DIMENSIONS.

FLEXIBLE DUCT RUNS SHALL BE LIMITED TO 5-0".

DIRECTION OF 30° OR GREATER.

ATTACH FLEXIBLE DUCTS TO DUCTWORK USING STAINLESS STEEL BAND CLAMPS.

11. FLEXIBLE CONNECTIONS

RUBBERIZED - CANVAS FLEXIBLE CONNECTIONS.

12. VOLUME DAMPERS

PROVIDE VOLUME DAMPERS, WHETHER INDICATED OR NOT, IN EVERY SUPPLY, RETURN, AND EXHAUST DUCT BRANCH FROM MAIN DUCT FITTED WITH LOCKING DEVICES FOR ADJUSTING THE AIR SUPPLY. PROVIDE ELEVATED DIAL REGULATORS FOR INSULATED DUCTS. INSTALL ADDITIONAL DAMPERS OF BAFFLES AS REQUIRED FOR FINAL AIR BALANCE.

13. VERIFY THE LOCATION, CAPACITY AND PERFORMANCE OF EXISTING EQUIPMENT IF THE EXISTING EQUIPMENT IS NOT FUNCTIONING AS RECOMMENDED BY THE MANUFACTURER, THIS CONTRACTOR SHALL REPAIR THE UNITS AS A PART OF THIS CONTRACT.


THE WORK DETAILED ON THESE PLANS IS BASED ON WHERE EXISTING FIELD CONDITIONS ARE DIFFERENT THAN SHOWN. THE CONTRACTOR SHALL ADVISE THE OWNER OF DISCREPANCIES WHICH WILL AFFECT THE PROPOSED WORK PRIOR TO BEGINNING THE WORK.

MECHANICAL SYMBOLS


DUCTWORK

REMOVE EQUIPMENT OR DUCTWORK

CHANGE IN ELEVATION- RISE(R) DROP(D)

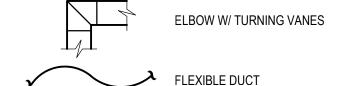

→ DIRECTION OF FLOW PIPE TURNING UP/DN

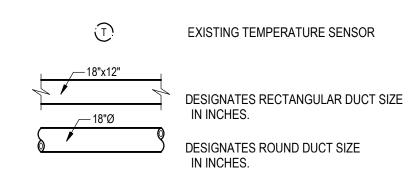


POINT OF DEMOLITION

CONNECTION TO EXISTING





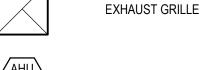

AHU # NEW EQUIPMENT DESIGNATION

EXISTING EQUIPMENT DESIGNATION EX AHU-#



GAUTHIER ALVARADO ASSOCIATES

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PROJECT TITLE

VIRGINIA DEPARTMENT OF TRANSPORTATION

> State Project No. 501-B2501-012

PETERSBURG & **SOUTH HILL RESIDENCY RESTROOM RENOVATIONS**



REVISIONS NO. DATE DESCRIPTION

GAA PROJECT NO. 768-E1 DRAWN BY JK

CHECKED BY RH 12-12-2022

MECHANICAL


COVER SHEET

DRAWING TITLE


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PETERSBURG - DEMOLITION FLOOR PLAN 1/4" = 1'-0" 5' 5'



PETERSBURG - NEW WORK FLOOR PLAN

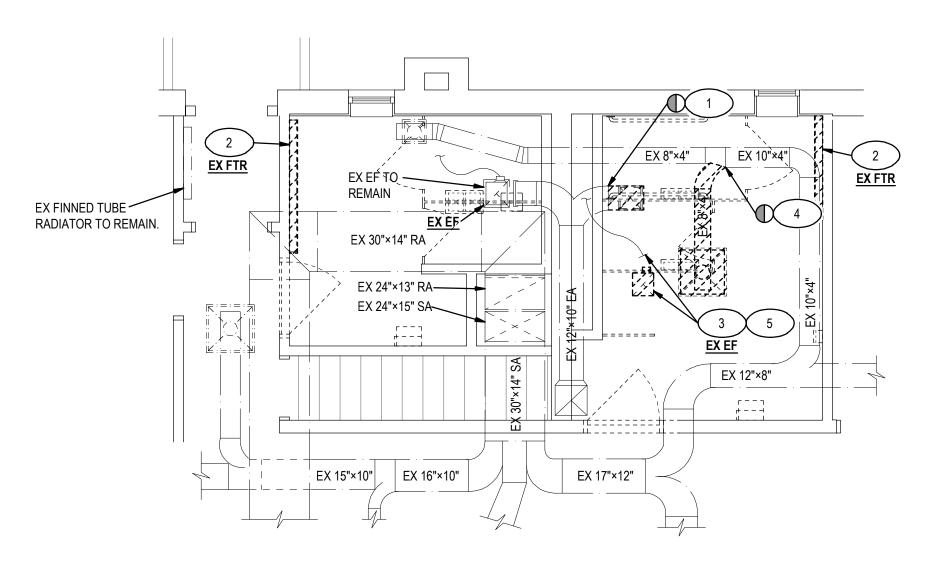
1/4" = 1'-0"

DEMOLITION KEY NOTES

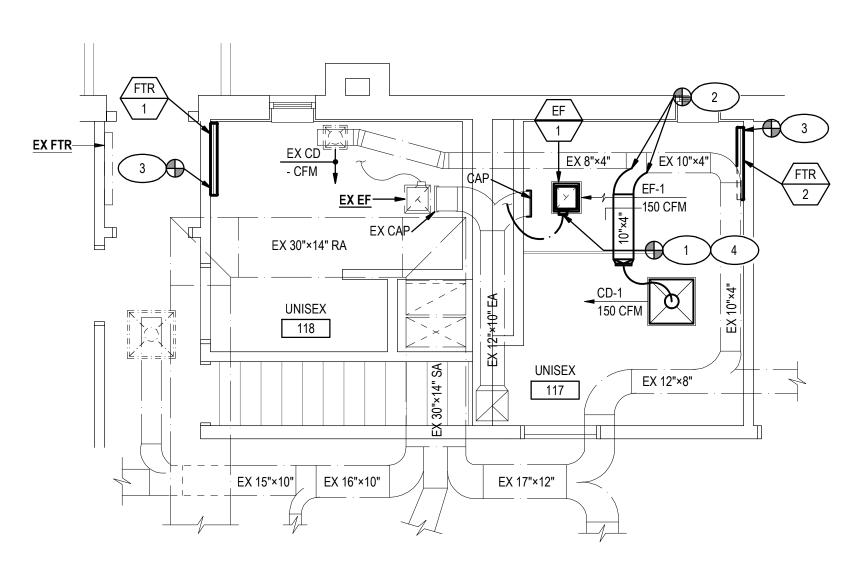- 1 REMOVE EXISTING EXHAUST GRILLE AND ALL ASSOCIATED COMPONENTS INCLUDING DUCTWORK TO POINT WHERE INDICATED AND CAP.
- 2 REMOVE EXISTING FINNED TUBE RADIATOR. RETAIN EX 1/2" HWS/R PIPING FOR NEW INSTALLATION.
- 3 REMOVE EXISTING CEILING MOUNTED EXHAUST FAN AND ALL ASSOCIATED COMPONENTS. RETAIN EXISTING FLEX DUCT FOR RECONNECTION.
- REMOVE EXISTING SUPPLY AIR DIFFUSER AND ALL ASSOCIATED COMPONENTS BACK TO MAIN. RETAIN DUCT TAP FOR NEW INSTALLATION.
- DISCONNECT EXISTING EXHAUST FAN AND MAINTAIN EXISTING ASSOCIATED ELECTRICAL COMPONENTS TO INCLUDE; MOTOR STARTER, DISCONNECT SWITCH, WIRING, AND BRANCH CIRCUIT CONDUIT FOR RECONNECTION TO NEW EQUIPMENT.

NEW WORK KEY NOTES

- 1 RECONNECT EXISTING EXHAUST FLEX DUCT TO EF-1.
- 2 EXTEND RIGID DUCT AND PROVIDE NEW FLEX DUCT TO SUPPLY AIR DIFFUSER IN THE LOCATION SHOWN.
- 3 RECONNECT EXISTING 1/2" HWS/R PIPING TO NEW HYDRONIC BASEBOARD HEATER AND CONFIRM PROPER OPERATION.
- 4 RECONNECT NEW EXHAUST FAN TO EXISTING BRANCH CIRCUIT WIRING AND ASSOCIATED EQUIPMENT FOR CONTROL AND DISCONNECT. FIELD VERIFY EXISTING VOLTAGE AND COORDINATE WITH PURCHASED EQUIPMENT.

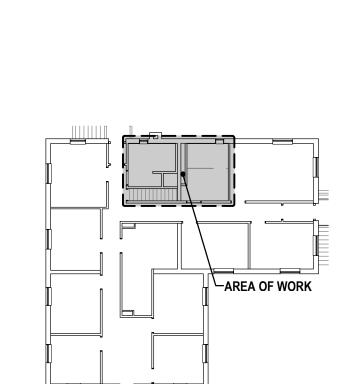

PETERSBURG - KEY PLAN

NOT TO SCALE



A L V A R A D O
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MECHANICAL

12-12-2022


PETERSBURG - DEMOLITION & NEW WORK FLOOR PLAN

PROJECT STATUS


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M101




SOUTH HILL - DEMOLITION FLOOR PLAN 1/4" = 1'-0"

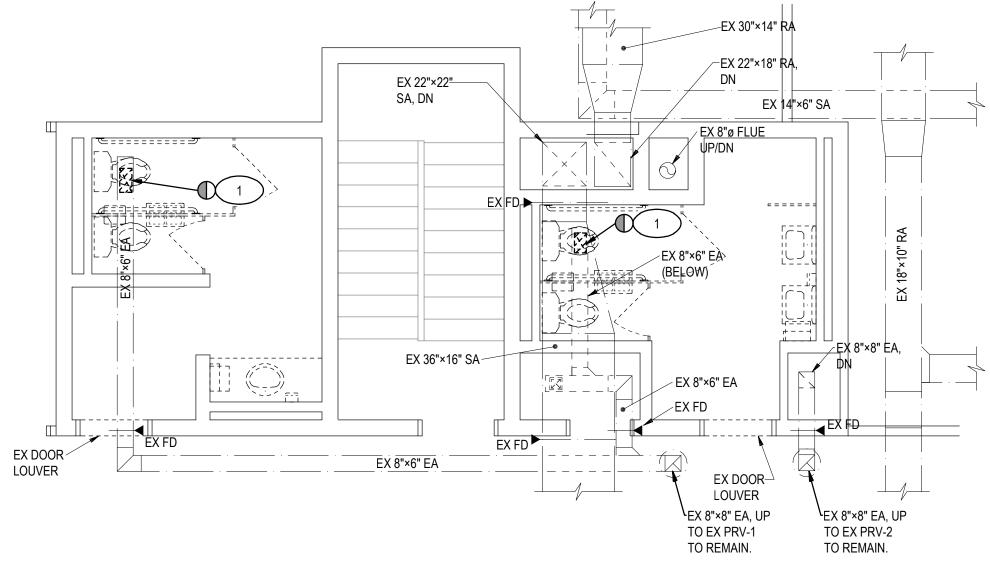

SOUTH HILL - NEW WORK FLOOR PLAN

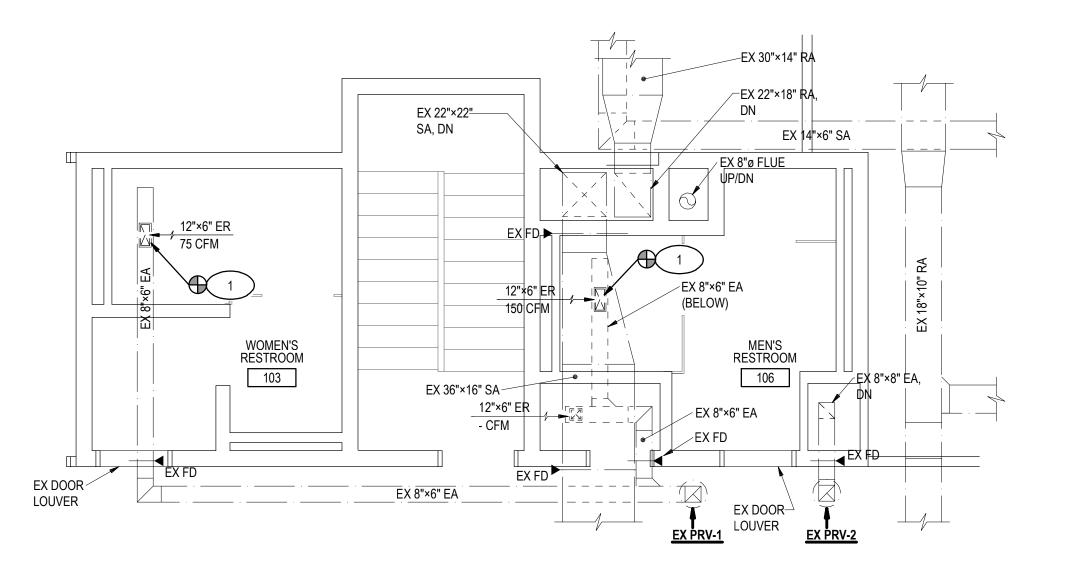1/4" = 1'-0"

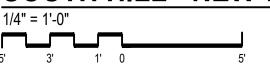

DEMOLITION KEY NOTES

NEW WORK KEY NOTES

INSTALLATION.

1 PROVIDE NEW EXHAUST REGISTER AND BALANCE TO AIR QUANTITIES SHOWN. MODIFY DUCT TAP AS NECESSARY FOR FINAL

1 REMOVE EXISTING EXHAUST GRILLE. RETAIN DUCTWORK AND OPENING FOR NEW INSTALLATION.

2 NOT USED.

3 NOT USED.

PROJECT TITLE

VIRGINIA DEPARTMENT OF TRANSPORTATION

GAUTHIER


ALVARADO

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ASSOCIATES

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DRAWING TITLE

MECHANICAL

SOUTH HILL - DEMOLITION & NEW WORK FLOOR PLAN

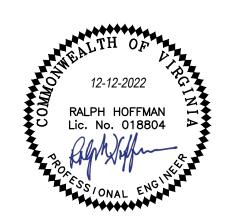PROJECT STATUS

PERMIT SUBMISSION

DRAWING NUMBER

M102

IFB # 157389

AREA OF WORK

SOUTH HILL - KEY PLAN
NOT TO SCALE

	FAN SCHEDULE														
DESIG	FACILITY	SERVES	LOCATED	TYPE	CFM	ESP	МНР	RPM	STARTER	DRIVE	ACCESSORIES	ELECTRICAL DATA	BASIS OF DESIGN	REMARKS	
DEGIG	TAGILITI	CERVEO	LOOKILD		0 1			MAX	0 17.11.12.11	512	7100200111120	VOLTS - PHASE - HERTZ	27.0.0 0. 220.0		
EF-1	PETERSBURG	UNISEX RESTROOM 117	UNISEX 117	Α	150	0.125	ı	-	HOA	DIRECT	-	120 - 1 - 60	SEE SPECIFICATIONS	RECONNECT TO EXISTING CONTROLS	

NOTES:

1. FAN TYPES: 'A' - CEILING MOUNTED FAN, 'B' - DOWNBLAST POWER ROOF VENTILATOR

2. PROVIDE DISCONNECTS FOR ALL FANS.

HYDRONIC BASEBOARD HEATER SCHEDULE													
WATER FLOW		ACTIVE											
DESIG FACILITY SERVES TYPE GPM AWT LWT P.D. FT. H2	CAP. BTUH/FT ROWS	LENGTH	HEIGHT (IN.)	DEPTH (IN.)	PROTOTYPE	REMARKS							
FTR-1 PETERSBURG UNISEX RESTROOM 118 A 1 150 140 -	510 1	3	7.25	3.5	SEE SPECIFICATIONS								
FTR-2 PETERSBURG UNISEX RESTROOM 117 A 1 150 140 -	510 1	3	7.25	3.5	SEE SPECIFICATIONS								

	CEILING DIFFUSER SCHEDULE													
DESIG.	SERVICE	CFM RANGE	NECK Size In.	OVERALL FACE DIM.	FACE	MOUNTING	PATTERN	FINISH	MAX NC LEVEL DB	MAX P.D IN. H20	PROTOTYPE:	REMARKS		
CD-1	SUPPLY	0 - 175	8	24 x 24	LOUV.	LAY-IN	4-W	NOTE 2	20	0.10	SEE SPECIFICATIONS	FULLY INSULATE TO OF DIFFUSER		


THE SAME SPECIFICATIONS AS SHOWN EXCEPT FOR THE MOUNTING TYPE. MOUNTING TYPE ON DIFFUSERS DESIGNATED "A" SHALL BE FLUSH SURFACE MOUNTED.

(1) HORIZONTAL AND VERTICAL AIR PATTERNS.

(2) COORDINATE FINISH WITH ARCHITECTURAL.

2. COORDINATE FINISH WITH ARCHITECTURAL.

	REGISTERS AND GRILLES SCHEDULE													
DESIG	DESIG SERVICE	CFM	FACE	FACE BLADES			FINISH	MAX. NC LEVEL	PROTOTYPE	ACCESSORIES	REMARKS			
DESIG	SERVICE	RANGE	(IN.)	DEFLEC.	SPACING	MATERIAL		dB	FROIDITE	(1)	NEWARKO			
ER	EXHAUST	-	AS SHOWN	SINGLE	3/4"	STEEL	NOTE 2	20	SEE SPECIFICATIONS	VD				
NOTES:	1. 'OBD' - OPF	POSED BLADE DAM	MPER; 'VD' - VOLU	JME DAMPER.										

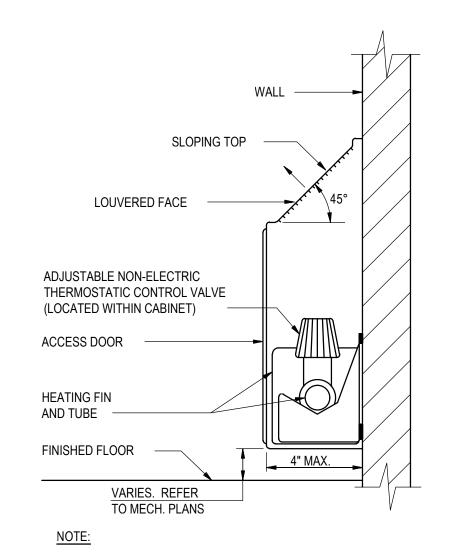


1. DETAIL BASED ON VULCAN - NST.

2. FOLLOW MANUFACTURER'S INSTALLATION DETAILS AND INSTRUCTIONS.


3. PROVIDE MOUNTING PLATES FOR COMPLETE INSTALLATION.

HYDRONIC BASEBOARD HEATER DETAIL NOT TO SCALE

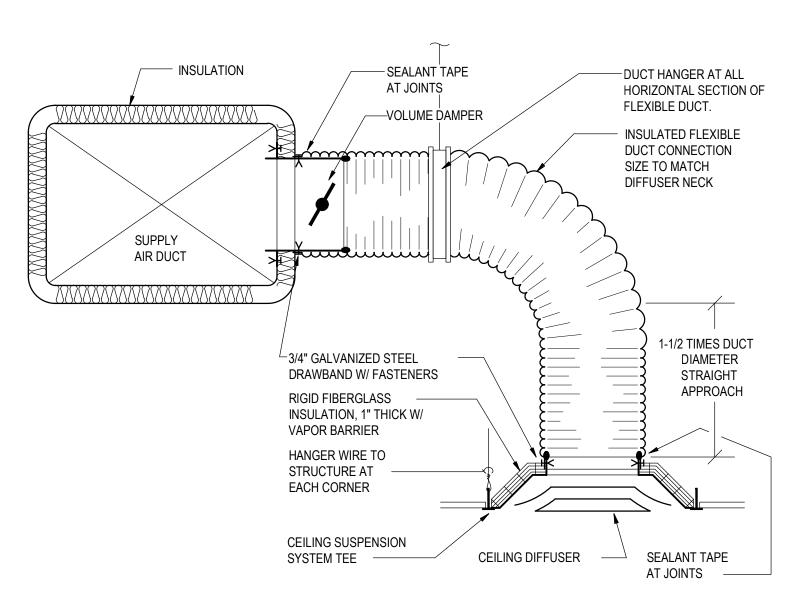

NOTE: 1. ALL FLEX DUCT SHALL BE 5'-0" MAX IN LENGTH. ALL BRANCH TAPS SHALL BE 2'-0" MIN. RIGID BEFORE FLEX CONNECTION.

CEILING DIFFUSER DETAIL
NOT TO SCALE

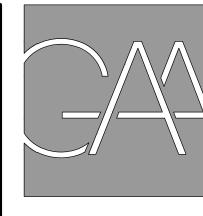

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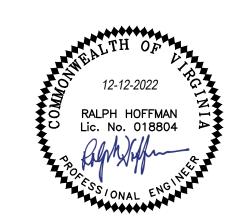
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PROJECT STATUS

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