SECTION EIGHT

VIII. ARCHITECTURAL SPECIFICATIONS AND DRAWINGS



BERKELEY MIDDLE SCHOOL INTERIOR RENOVATION-PAINT AND CARPET

Guernsey Tingle

4350 New Town Avenue, Suite 101 Williamsburg, VA 23188

SCHEDULE OF DRAWINGS						
GENERAL						
G-101	TITLE SHEET					
ARCHITECTURAL						
A-001	LEGENDS AND ABBREVIATIONS					
A-030	ARCHITECTURAL SPECIFICATIONS					
A-031	ARCHITECTURAL SPECIFICATIONS					
A-101	FLOOR PLAN – FIRST FLOOR					
A-102	ENLARGED FLOOR PLAN – AREA A ALTERATIONS					
A-103	ENLARGED FLOOR PLAN – AREA B ALTERATIONS					
A-104	ENLARGED FLOOR PLAN – AREA C ALTERATIONS					
A-105	ENLARGED FLOOR PLAN – AREA D ALTERATIONS					
A-106	ENLARGED FLOOR PLAN – MEDIA CENTER ALTERATIONS					
A-601	HOLLOW METAL FRAME ELEVATIONS & DETAILS					
A-602	HOLLOW METAL FRAME ELEVATIONS & DETAILS					

WJCC BERKELEY MIDDLE SCHOOL FINISHES

1118 Ironbound Rd, Williamsburg, VA 23188

BUILDING CODE SUMMARY

THIS IS AN INTERIOR RENOVATION OF AN EXISTING SPACE THAT IS A LEVEL I ALTERATION. CARPETING WILL BE REMOVED AND REPLACED IN CERTAIN AREAS. WALLS AND STOREFRONT WILL BE PAINTED.

REQUIRED PLUMBING FIXTURES

PLUMBING FIXTURE COUNTS TO REMAIN UNCHANGED.

ALL CONSTRUCTION SHALL COMPLY WITH THE REQUIREMENTS OF 2018 VIRGINIA EXISTING BUILDING CODE

BUILDING DATA:

OCCUPANCY CLASSIFICATION: E, EDUCATIONAL
CONSTRUCTION TYPE: TYPE 2A
FIRE SUPPRESSION SYSTEM: YES
ALLOWABLE BUILDING AREA AND HEIGHT (IBC 507.3):
ALLOWABLE AREA: BASE ALLOWED EXISTING TO REMAIN
FRONTAGE INCREASE EXISTING TO REMAIN
TOTAL ALLOWABLE AREA EXISTING TO REMAIN
ACTUAL AREA: EXISTING TO REMAIN
ALLOWABLE HEIGHT: EXISTING TO REMAIN
ACTUAL HEIGHT: EXISTING TO REMAIN

OCCUPANCY:

OCCUPANCY LOAD IS EXISTING TO REMAIN

FIRE RESISTANCE RATINGS:

STRUCTURAL FRAME: EXISTING TO REMAIN BEARING EXTERIOR WALLS: EXISTING TO REMAIN BEARING INTERIOR WALLS: EXISTING TO REMAIN NON BEARING EXTERIOR WALLEXISTING TO REMAIN NON BEARING INTERIOR WALLEXISTING TO REMAIN FLOOR CONSTRUCTION: EXISTING TO REMAIN ROOF CONSTRUCTION: EXISTING TO REMAIN CORRIDOR WALLS: EXISTING TO REMAIN

MATERIAL FINISH RATINGS: (REQUIRED)

CORRIDORS: CLASS 2 FLOORS AND CLASS B WALLS AND CEILINGS ROOMS AND AREAS: CLASS 2 FLOORS AND CLASS C WALLS AND CEILINGS

LIFE SAFETY SYSTEM:

EMERGENCY LIGHTING:YESEXIT SIGNS:YESFIRE DETECTION SYSTEM:YES

EXIT REQUIREMENTS:

EDUCATIONAL / GROUP "E"
DEAD-END LIMIT MAXIMUM
COMMON PATH OF EGRESS TRAVEL:
MAXIMUM TRAVEL TO EXIT:
ACTUAL (MAXIMUM) TRAVEL TO EXIT:
MINIMUM NUMBER OF EXITS:

EGRESS WIDTH:

EXISTING TO REMAIN EXISTING TO REMAIN

GENERAL CONSTRUCTION NOTES

A. G.C. SHALL INSPECT ALL DRAWINGS IMMEDIATELY UPON RECEIPT & REPORT ANY DISCREPANCIES, CONFLICTS, ERRORS, OR OMISSIONS DISCOVERED. THIS INCLUDES COORDINATION WITH MEP/OTHER

TRADES.

B. G.C. IS RESPONSIBLE FOR ENSURING ALL WORK IS DONE IN ACCORDANCE WITH ACCEPTED CONSTRUCTION STANDARDS & IN COMPLIANCE WITH ALL BUILDING CODES, ORDINANCES & REGULATIONS OF ALL CONSTITUTED PUBLIC AUTHORITIES HAVING JURISDICTION.

A WRITTEN VARIANCE IS APPROVED BY THE OWNER.

D. G.C. & ALL SUBCONTRACTORS SHALL VISIT & INSPECT THE PREMISES PRIOR TO SUBMITTING A PROPOSAL. SUBMISSION OF A PROPOSAL CONSTITUTES AN AGREEMENT THAT THE G.C. INCLUDED ALL ITEMS NECESSARY TO ACCOMMODATE THE EXISTING CONDITIONS. ANY CONDITIONS IN CONFLICT WITH

E. G.C. SHALL OBTAIN ALL PERMITS & THE CERTIFICATE OF OCCUPANCY, UNLESS NOTED OTHERWISE.
F. MATERIALS SHALL BE DELIVERED & STORED IN ORIGINAL, UNOPENED PROTECTIVE PACKAGING.
INSPECT LABELS IMMEDIATELY UPON DELIVERY FOR ACCURACY. STORE & INSTALL ACCORDING TO
MANUFACTURER'S INSTRUCTIONS. PREVENT DAMAGE TO MATERIALS & SURROUNDING SURFACES

WHEN HANDLING.
G. G.C. SHALL KEEP A CLEAN & SECURE JOB SITE & TAKE ADEQUATE MEASURES TO PROTECT BUILDING & SITE OCCUPANTS & ITEMS SALVAGED FOR REUSE & IS RESPONSIBLE FOR RETURNING ANY DAMAGED ITEMS TO "LIKE NEW" CONDITION. OCCUPIED/PUBLIC AREAS SHALL BE KEPT CLEAR OF CONSTRUCTION MATERIALS. SECURITY, NOISE, & DUST BARRIERS SHALL BE MAINTAINED BY G.C. BETWEEN AREAS OF CONSTRUCTION & OCCUPIED/PUBLIC AREAS.

H. G.C. SHALL PERFORM FINAL CLEANING PRIOR TO END USE OCCUPANCY TO INCLUDE: VACUUMING & REMOVAL OF DUST, DEBRIS, OILS, STAINS, FINGERPRINTS, LABELS & WALLCOVERING ADHESIVE.
 I. G.C. IS RESPONSIBLE FOR PROVIDING A COMPLETE & OPERATIONAL SPACE.

I. WITHIN 30 DAYS OF PROJECT COMPLETION, G.C. SHALL PROVIDE REPRODUCIBLE SCALED AS-BUILTS TO THE OWNER & THE ARCHITECT. THESE AS-BUILTS SHALL REFLECT FINAL FIELD CONDITIONS AT PROJECT COMPLETION.

K. WITHIN 60 DAYS OF PROJECT COMPLETION, G.C. SHALL PROVIDE THE END USER WRITTEN DOCUMENTATION OF ALL WARRANTIES & RECOMMENDED MAINTENANCE PROCEDURES FOR ALL

L. TO THE BEST OF OUR KNOWLEDGE & INFORMATION, THESE DRAWINGS HAVE BEEN PREPARED IN CONFORMITY WITH ANSI STANDARD A117.1 2009 & ADA TITLE III FOR MAKING BUILDINGS & FACILITIES ACCESSIBLE TO & USABLE BY PERSONS WITH DISABILITIES. ALTERATIONS, EXCEPTIONS & DELETIONS TO THESE RULES BY THE RESIDING JURISDICTION HAVE BEEN ACCOMMODATED TO THE BEST OF OUR

M. OMISSIONS: IF CERTAIN FEATURES ARE NOT FULLY SHOWN OR CALLED OUT ON THE DRAWINGS OR NOTES, THEIR CONSTRUCTION SHALL BE OF THE SAME CHARACTER AS FOR SIMILAR CONDITIONS THAT ARE SHOWN OR CALLED OUT.

N. INSTALLATION OF ALL PRODUCTS SHALL BE AS REQUIRED BY THE MANUFACTURER'S LATEST WRITTEN INSTRUCTIONS AT THE TIME OF PERMITTING.

O. CONTROLS & OPERATING MECHANISMS FOR ALL FIXTURES & FURNISHINGS SHALL BE OPERABLE BY A FORCE OF NO GREATER THAN 5 LBF WITH ONE HAND & NOT REQUIRE TIGHT GRASPING, PINCHING OR TWISTING OF THE WRIST TO ACTIVATE CONTROLS.

P. THE SELECTED CONTRACTOR SHALL SUPPLY ALL MISC. BLOCKING, BRACING, METAL, TRIM, FASTENERS, HARDWARE, ETC AS REQUIRED TO COMPLETE THE WORK HERE-IN.

Q. ALL REQUIRED ACCESSIBLE ELEMENTS SHALL BE IDENTIFIED BY ADA/ACCESSIBILITY SIGNAGE HAVING THE INTERNATIONAL SYMBOL OF ACCESSIBILITY. TO BE INSTALLED IN ACCORDANCE WITH IBC SECTION.

THE INTERNATIONAL SYMBOL OF ACCESSIBILITY, TO BE INSTALLED IN ACCORDANCE WITH IBC SECTION 1013.4 (EXIT SIGNS), SECTION 1111 (ACCESSIBILITY SIGNAGE), AND ANSI 117.1 SECTION 703 (SIGNS) ON THE WALL ADJACENT TO THE LATCH SIDE OF THE DOOR OR NEAREST ADJACENT WALL. REFER TO SHEET A-001 FOR SIGN DETAILS AND SIGNAGE PLANS, IF INCLUDED, FOR SIGN LOCATIONS.

R. G.C. SHALL REVIEW SPECIFICATIONS & DRAWINGS & VERIFY LEAD TIMES AT TIME OF BID/PRICING

SUBMISSION.
S. ITEMS INDICATED AS "SALVAGED" SHALL BE RELOCATED FROM THE EXISTING BUILDING & INSTALLED BY THE CONTRACTOR.

BID ALTERNATE #1: ALL WORK ASSOCIATED WITH THE MEDIA CENTER CASEWORK

ASBESTOS / LEAD PAINT TESTING:

Renovation or Demolition Asbestos Abatement Statement (greater than four dwelling units):

The Owner has performed a thorough asbestos inspection and subsequent reporting as required by OSHA: 29 CFR 1926 (Construction and Maritime), EPA NESHAP: 40 CFR 61 Subpart M, and the Code of Virginia Chapter 3.3, Virginia Asbestos NESHAP Act, Sections 40.1-51.23 to 40.1-51.41.Renovation or demolition of buildings are subject to asbestos NESHAP, regardless of the structure's age. Asbestos abatement is the responsibility of the Contractor, per OSHA regulations, and is included as part of this scope of work.

<u>Child-Occupied Facilities Renovation or Demolition Lead-Based Paint Abatement</u>
Statement:

The Owner has performed a lead-based paint inspection and subsequent reporting as required by Title X, EPA Renovate, Repair, and Paint Rule (40 CFR 745) and current HUD Chapter 7 Guidelines (if HUD or federal funding is involved in the project funding). Individuals disturbing lead must be properly trained when disturbing any potentially lead-based paint elements, per the EPA's Lead Renovation, Repair, and Painting Rule (RRP). Lead-based paint abatement is the responsibility of the Contractor, per the applicable regulations, and is included as part of this scope of work

VICINITY PLAN



DRAWING INDEX

G-101 TITLE SHEET ARCHITECTURAL LEGENDS AND ABBREVIATIONS ARCHITECTURAL SPECIFICATIONS ARCHITECTURAL SPECIFICATIONS A-101 FLOOR PLAN - 1ST FLOOR **ENLARGED FLOOR PLAN - AREA A ALTERATIONS** A-103 **ENLARGED FLOOR PLAN - AREA B ALTERATIONS ENLARGED FLOOR PLAN - AREA C ALTERATIONS ENLARGED FLOOR PLAN - AREA D ALTERATIONS** ENLARGED FLOOR PLAN - MEDIA CENTER HOLLOW METAL FRAME ELEVATIONS & DETAILS HOLLOW METAL FRAME ELEVATIONS & DETAILS

PROJECT TEAM

OWNER


WILLIAMSBURG JAMES CITY COUNTY SCHOOLS JIM FALZONE 597 JOLLY POND

ARCHITECT

WILIAMSBURG, VA 23188

GUERNSEYTINGLE 4350 NEW TOWN AVENUE, SUITE 101 WILLIAMSBURG, VIRGINIA 23188 757-220-0220 Guernsey
757-220-0220 Will

WJCC BERKELEY MIDDL SCHOOL FINISHES

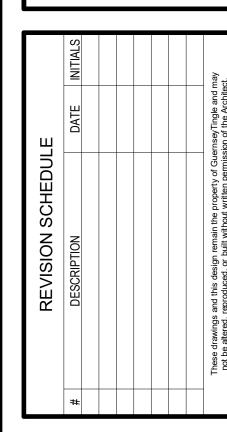

TITLE SHEET


Date: 3/1/2024

Drawn: TOG Checked: SLK

Project: 223133

3/1/2024

G-101

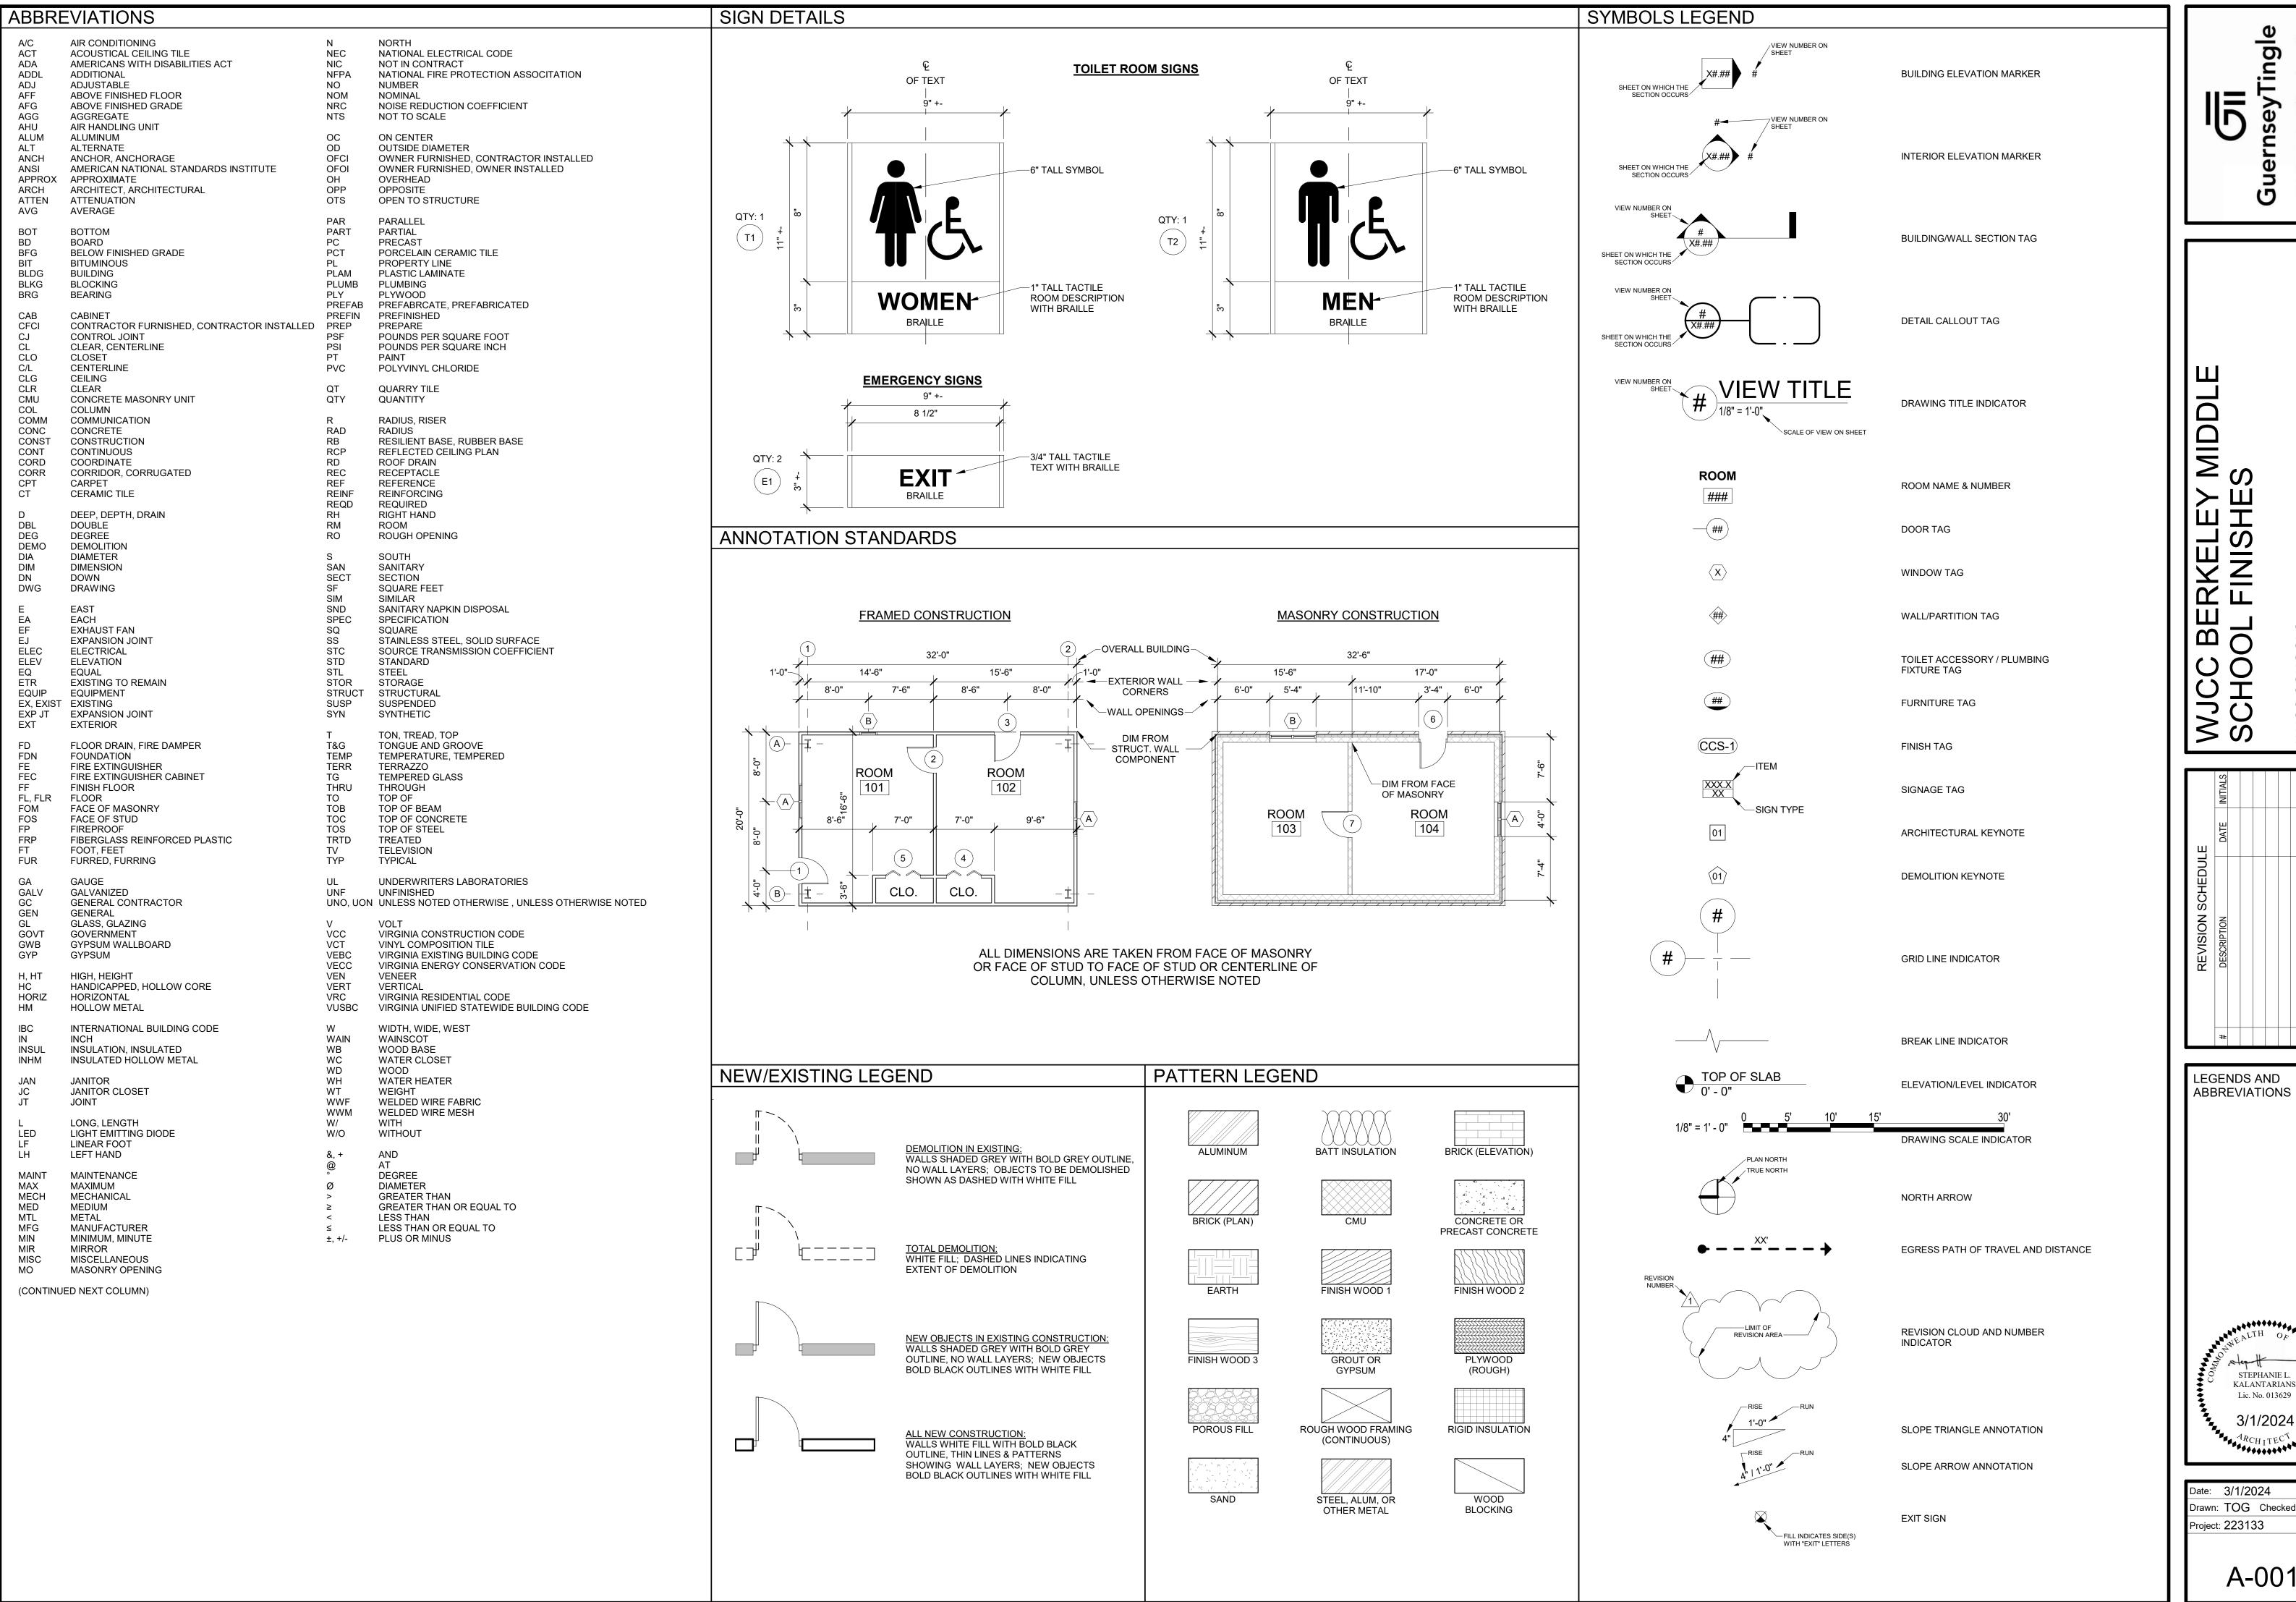

eyT e

U

MIDDLI S RKELEY FINISHES BE

LEGENDS AND

STEPHANIE L. KALANTARIANS Lic. No. 013629

Date: 3/1/2024 Drawn: TOG Checked: SLK Project: 223133

3/1/2024

TABLE OF CONTENTS

TITLE	SECTION
DIVISION 1 - GENERAL REQUIREMENTS	
SUMMARY OF WORK	011000
ALTERNATES	013000
SUBMITTAL PROCEDURES	013300
PROJECT CLOSEOUT	017800
DIVISION 6 - WOOD AND PLASTICS	
ROUGH CARPENTRY	061000
FINISH CARPENTRY	062000
DIVISION 9 - FINISHES	
GYPSUM DRYWALL	092900
RESILIENT FLOORING	096500
CARPETING	096800
PAINTING	099000

SECTION 011000 - SUMMARY OF WORK

WORK UNDER THIS CONTRACT

A. THE WORK REQUIRED CONSISTS OF FURNISHING ALL PLANT, EQUIPMENT, SUPERINTENDENCE, LABOR, SKILL AND MATERIALS NECESSARY FOR THE CONSTRUCTION OF THE FOLLOWING WORK:

RENOVATION OF BERKELEY MIDDLE SCHOOL. WORK SHALL GENERALLY INCLUDE: DEMOLITION OF SOME EXISTING CASEWORK, PAINTING OF SOME WALLS AND CEILINGS, REMOVAL AND REPLACEMENT OF CARPETING, LAMINATE-CLAD CASEWORK.

- B. THE CONTRACTOR SHALL PERFORM WORK NECESSARY FOR ALL CONSTRUCTION INCLUDING FURNISHING OF ALL ENGINEERING NECESSARY FOR THE DETERMINATION OF ALL QUANTITIES FOR THE LAYOUT OF THE WORK, IN ACCORDANCE WITH THE APPLICABLE DRAWINGS AND SPECIFICATIONS, AND IN ACCORDANCE WITH THE CONTRACT DOCUMENTS.
- C. THE CONTRACTOR SHALL OBTAIN AND PAY FOR A BUILDING PERMIT AND SHALL COORDINATE REQUIRED INSPECTIONS.

3. APPLICABLE CODES

- A. ALL REFERENCES TO CODES, SPECIFICATIONS, AND STANDARDS IN THE SPECIFICATION SECTIONS AND ON THE DRAWINGS SHALL MEAN, AND ARE INTENDED TO BE, THE MOST CURRENT EDITION, AMENDMENT AND/OR REVISION OF SUCH REFERENCE STANDARD IN EFFECT AS OF THE DATE OF THESE CONTRACT DOCUMENTS.
- B. ALL CONSTRUCTION SHALL COMPLY WITH THE 2018 EDITION OF THE VIRGINIA EXISTING BUILDING CODE (VEBC).

SECTION 013000 - ALTERNATES

- 1. DEFINITION: AN ALTERNATE IS AN AMOUNT PROPOSED BIDDERS AND STATED ON THE BID FORM THAT WILL BE ADDED TO OR DEDUCTED FROM THE BASE BID AMOUNT IF THE OWNER DECIDES TO ACCEPT A CORRESPONDING CHANGE IN EITHER THE SCOPE OF WORK OR IN PRODUCTS, MATERIALS, EQUIPMENT, SYSTEMS OR INSTALLATION METHODS DESCRIBED IN THE CONTRACT DOCUMENTS.
- WORK INCLUDED: MISCELLANEOUS DEVICES, APPURTENANCES AND SIMILAR ITEMS INCIDENTAL TO OR REQUIRED FOR COMPLETE PROVISION OF THE ALTERNATE, WHETHER OR NOT MENTIONED AS PART OF THE ALTERNATE.
- 3. COORDINATION: COORDINATE RELATED WORK AND MODIFY OR ADJUST ADJACENT WORK AS REQUIRED TO ENSURE THAT WORK AFFECTED BY EACH ACCEPTED ALTERNATE IS COMPLETE AND FULLY INTEGRATED INTO THE PROJECT.

SECTION 013300 – SUBMITTAL PROCEDURES

- 1. PROVIDE SUBMITTALS TO THE OWNER FOR REVIEW AND APPROVAL. SUBMITTALS SHALL INCLUDE:
 - A. ANY REQUIREMENTS INDICATED IN THE BID DOCUMENTS TO INCLUDE SCHEDULE OF VALUES, PROJECT SCHEDULE, INSURANCE CERTIFICATIONS, ETC.
 - B. PRODUCT INFORMATION ADEQUATE TO CONFIRM CONFORMANCE WITH PROJECT REQUIREMENTS
 - C. FINISH SAMPLES, COLORS, ETC. TO VERIFY PROPOSED FINISHES
 - D. WARRANTY MATERIALS E. CLOSEOUT DOCUMENTS
- SUBMIT PRODUCTS AS SOON AS POSSIBLE, SO THAT PROJECT PROGRESS IS NOT HINDERED BY INABILITY TO OBTAIN PRODUCTS IN A TIMELY MANNER. PAY PARTICULAR ATTENTION TO PRODUCTS WITH LONG LEAD TIMES.

SECTION 017000 - PROJECT CLOSEOUT

- 1. GENERAL DEFINITIONS: THE PROVISIONS OF THIS SECTION APPLY PRIMARILY TO CLOSEOUT OF ACTUAL PHYSICAL WORK, NOT TO ADMINISTRATIVE MATTERS SUCH AS FINAL PAYMENT AND CHANGEOVER OF INSURANCES. CLOSEOUT REQUIREMENTS RELATE TO BOTH FINAL COMPLETION AND SUBSTANTIAL COMPLETION OF THE WORK AND APPLY TO INDIVIDUAL PORTIONS OF COMPLETED WORK AS WELL AS THE TOTAL WORK. SPECIFIC REQUIREMENTS IN OTHER SECTIONS HAVE PRECEDENCE OVER GENERAL REQUIREMENTS.
- 2. PROCEDURES AT SUBSTANTIAL COMPLETION:
- A. PREREQUISITES: COMPLY WITH GENERAL CONDITIONS AND COMPLETE THE FOLLOWING BEFORE REQUESTING OWNER AND/OR ARCHITECT'S/ENGINEER'S INSPECTION OF THE WORK, OR DESIGNATED PORTION THEREOF, FOR SUBSTANTIAL COMPLETION:
- 1. SUBMIT CERTIFICATE OF OCCUPANCY, ENABLING OWNER'S UNRESTRICTED OCCUPANCY AND USE.
- 2. SUBMIT MAINTENANCE INSTRUCTIONS, TOOLS, SPARE PARTS, KEYS AND SIMILAR OPERATIONAL ITEMS.
- 3. COMPLETE INSTRUCTION TO OWNER OF OPERATING PROCEDURES AND START-UP OF SYSTEMS.
- B. INSPECTION PROCEDURES: UPON RECEIPT OF CONTRACTOR'S REQUEST, OWNER AND/OR ARCHITECT/ENGINEER WILL EITHER PROCEED WITH INSPECTION OR ADVISE CONTRACTOR OF PREREQUISITES NOT FULFILLED. FOLLOWING INITIAL INSPECTION, OWNER OR ARCHITECT/ENGINEER WILL EITHER PREPARE CERTIFICATE OF SUBSTANTIAL COMPLETION OR ADVISE CONTRACTOR OF WORK WHICH MUST BE PERFORMED PRIOR TO ISSUANCE OF CERTIFICATE; AND REPEAT INSPECTION WHEN REQUESTED AND ASSURED THAT WORK HAS BEEN SUBSTANTIALLY COMPLETE. RESULTS OF COMPLETED INSPECTION WILL FORM INITIAL "PUNCH LIST" FOR FINAL ACCEPTANCE. ANY REPEAT INSPECTIONS BY THE ARCHITECT/ENGINEER WILL BE PAID FOR BY THE CONTRACTOR.

- 3. RECORD DOCUMENTS: MAINTAIN A SEPARATE PROJECT SET OF DRAWINGS ON EACH JOB SITE THAT IS ONLY TO RECORD CHANGES IN THE WORK AND CONDITIONS THAT DIFFER FROM WHAT IS INDICATED ON THE DRAWINGS. KEEP AN ONGOING RECORD OF THESE THINGS ON THIS DRAWING SET AND SUBMIT THIS TO THE OWNER PRIOR TO FINAL COMPLETION. FINAL ACCEPTANCE AND FINAL PAYMENT WILL NOT BE AUTHORIZED UNTIL RECORD DOCUMENTS ARE TURNED IN AND ACCEPTED BY THE OWNER AS A COMPLETE RECORD OF THE WORK. FAILURE TO MAINTAIN THE MARKED-UP DRAWING SETS MAY HINDER PROGRESS PAYMENTS.
- 4. PROCEDURES AT FINAL ACCEPTANCE REINSPECTION PROCEDURE: UPON RECEIPT OF CONTRACTOR'S NOTICE THAT WORK HAS BEEN COMPLETED, INCLUDING PUNCH LIST ITEMS RESULTING FROM EARLIER INSPECTION(S) EXCEPT INCOMPLETE ITEMS DELAYED BECAUSE OF ACCEPTABLE CIRCUMSTANCES, ARCHITECT WILL REINSPECT WORK. UPON COMPLETION OF REINSPECTION. OWNER'S REPRESENTATIVE AND/OR ARCHITECT/ENGINEER WILL EITHER RECOMMEND FINAL ACCEPTANCE AND FINAL PAYMENT OR ADVISE CONTRACTOR OF WORK NOT COMPLETED OR OBLIGATIONS NOT FULFILLED AS REQUIRED FOR FINAL ACCEPTANCE. IF NECESSARY, PROCEDURE WILL BE REPEATED. ANY REPEAT INSPECTIONS BY THE ARCHITECT/ENGINEER WILL BE PAID FOR BY THE CONTRACTOR.

SECTION 061000 - ROUGH CARPENTRY

- 1. ALL LUMBER USED IN THE WORK SHALL BE FIRE-TREATED LUMBER, BEARING CERTIFICATIONS VALIDATING COMPLIANCE.
- 2. PROVIDE FRAMING FOR MEDIA CENTER CIRC DESK AND COUNTERTOPS, AS

SECTION 062000 - FINISH CARPENTRY

1. CIRCULATION DESK: FABRICATE CIRCULATION DESK AS INDICATED. USE PLASTIC LAMINATE FOR THE FINISHED WORK SURFACE OF THE CIRCULATION DESK AS INDICATED. FORM A CONTINUOUS SURFACE, USING INDUSTRY-STANDARD PRACTICES FOR ADHERING PLASTIC LAMINATE TO A PLYWOOD SUBSTRATE TO PROVIDE SEAMLESS-APPEARING JOINTS, AND TO ADHERE/FASTEN MATERIALS TO SUBSTRATES FOR A PERMANENT INSTALLATION. PROVIDE A MOCKUP FOR EACH TYPE OF INSTALLATION FOR APPROVAL PRIOR TO PROCEEDING WITH FABRICATION OF THE REST OF THE WORK. THE MOCKUP, IF ACCEPTED, MAY BECOME PART OF THE FINISHED WORK.

SECTION 092500 - GYPSUM WALLBOARD

- 1. GYPSUM WALLBOARD FOR WALLS SHALL BE 5/8" IMPACT-RESISTANT GYPSUM WALLBOARD
- 2. A 1/4" JOINT SHALL BE LEFT WHERE GYPSUM WALLBOARD ABUTS THE FLOOR, SOFFITS, STRUCTURAL STEEL COLUMNS, AND CMU WALLS TO CREATE A JOINT WHICH SHALL THEN BE FILLED WITH BACKER ROD AND SEALANT.

SECTION 09 65 00 - RESILIENT FLOORING

PART 1 PRODUCTS

1.1 WALL BASE (Abbrev BV-1)

Conform to ASTM F1861, Type TS (vulcanized thermoset rubber), Group 1 (solid, homogenous), Style B (coved – standard toe). Provide 4 inch high and a minimum 1/8 inch thick wall base. Provide job formed corners in matching height, shape and color. Homogenous rubber compound to be comprised of a premium blend and SBR rubber

Material length: 120 foot roll form Surface burning ASTM E84: Class B Flammability/ Critical Radiant Flux ASTM E648: Class B Smoke Density ASTM E662: Passes (<450)

Base product must contain a minimum of 10% natural rubber

1.2 MOULDING

Provide tapered mouldings of vinyl or rubber and types as recommended by flooring manufacturer for both edges and transitions of flooring materials specified. Provide vertical lip on moulding of maximum ¼ inch. Provide bevel change in level between ¼ and ½ inch with a slope no greater than 1:2.

1.3 ADHESIVES

Provide adhesives for base as recommended by the manufacturer and comply with local indoor air quality standards. Submit manufacturer's descriptive data, documentation stating physical characteristics, and mildew and germicidal characteristics. Provide non-aerosol adhesive products used on the interior of the building (defined as inside of the weatherproofing system).

1.4 MANAFACTURER'S COLOR, PATTERN AND TEXTURE Provide color, pattern and texture for resilient accessories as indicated on the drawings and in the "Finish Schedule". Color listed is not intended to limit the selection of equal colors from other manufacturer's.

PART 3 EXECTUION

3.1 PLACING MOUDLING

Provide moulding where flooring termination is higher than the adjacent finished flooring and at transitions between different flooring materials. When required, locate moulding under door centerline. Moulding is not required at doorways where thresholds are provided. Secure moulding with adhesive as recommended by the manufacturer. Prepare and apply adhesives in accordance with manufacturer's printed directions. Anchor aluminum moulding to floor surfaces as recommended by the manufacturer.

3.2 PLACING WALL BASE

Install wall base in accordance with manufacturer's printed installation instructions. Prepare and apply adhesives in accordance with manufacturer's printed directions. Tighten base joints and make even with adjacent flooring. Fill voids along the top edge of base as masonry walls with caulk. Roll entire vertical surface of base with hand roller and press toe of base with a straight piece of wood to ensure proper alignment. Avoid excess adhesive in corners.

SECTION 09 68 00 - CARPETING

PART 1 GENERAL

1.1 WARRANTY

Provide manufacturer's standard performance guarantees or warranties including a lifetime commercial warranty covering fiber abrasive wear, static protection, staining and colorfastness to light and atmospheric contaminants.

PART 2 PRODUCTS

2.1 CARPET

Furnish first quality carpet that is free of visual blemishes, streaks, poorly dyed areas, fuzzing of pile yarn, spots or stains and other physical and manufacturing defects. Provide carpet materials and treatments as reasonably nonallergenic and free of other recognized health hazards. Provide static control construction on all grade carpets which gives adequate durability and performance. Submit manufacturer's catalog date and printed documentation stating physical characteristics for each type of carpet material and installation accessory. Submit manufacturer's Product Data for 1) Carpet, 2) Moldings, and 3) Carpet Cushion. Also, submit samples of the following:

- a. Carpet: Two "Production Quality" samples 18 by 18 inches minimum of each carpet proposed for use, showing quality, pattern and color specified
- b. Moldings: Two samples of each type, minimum 12 inches long
- c. Carpet Cushion: Two samples minimum 6 by 6 inches

2.2.1 RECYCLED CONTENT

Carpeting must contain a minimum of 58% pre-consumer recycled content. Provide data identifying percentage of recycled content for carpeting.

Provide certification of indoor air quality for carpet.

2.2.2 Physical Characteristics for Modular Carpet Tile

2.2.2.1 Carpet Construction

2.2.2.2 Type (Abbrev. CPT-1, CPT-2)

The following applies to all abbreviation types unless noted otherwise. Modular tile with 0.15 percent growth/shrink rate in accordance with ISO 2551. All abbreviation types must come from the same subsidiary manufacturer. Abbreviation type CPT-1 must be majority warm grey tones with a minimum of two accent colors; one being red and no more than ten percent of the overall carpet coloring. It must also be geometric / rectangular in style. Abbreviation type CPT-2 must be of the same style and must be a solid red color or "read" as a solid color from a 3'-0" distance. The red should match the red in CPT-1. Refer to the Finish Schedule.

2.2.2.3 Pile Type

Multi-Level Pattern Loop

2.2.2.4 Pile Fiber

Commercial 100 percent branded (federally registered trademark) nylon continuous filament. Nylon must be Type 6.6 or Type 6.0 with a cross-section modification ratio no greater than 2.1.

2.2.2.5 Gauge or Pitch

Minimum 1/10 inch in accordance with ASTM D5793

2.2.2.6 Stitches or Rows/Wires

Minimum 8.5 per square inch for Types CPT-1 and CPT-2.

2.2.2.7 Surface Pile Weight

Minimum 16 ounces per square yard for Types CPT-1 and CPT-2. This does not include weight of backings. Determine weight in accordance with ASTM D5848.

2.2.2.8 Pile Thickness

Minimum 0.09 inch for Types CPT-1 and CPT-2 in accordance with ASTM D6859.

2.2.2.9 Pile Density

Minimum 6100

2.2.2.10 Dye Method

100% Solution dyed for all types.

2.2.2.11 Backing Materials

Provide primary backing materials like those customarily used and accepted by the trade for each type of carpet. Provide secondary backing to suit project requirements of those customarily used and accepted by the trade for each type of carpet.

- 2.3 PERFORMANCE REQUIREMENTS
- 2.3.1 Texture Appearance Retention Rating (TARR)

Provide carpet with a greater than or equal to 3.5 (Severe) for CPT-1 and CPT-2 in accordance with ASTM D7330 or CRI Test Method 103.

2.3.2 Static Control

Provide static control to permanently regulate static buildup to less than 3.5 kV when tested at 20 percent relative humidity and 70 degrees F in accordance with AATCC 134.

2.3.3 Compression Force Deflection at 65 Percent

Appropriate standards for offices, cubical areas and corridors in accordance with ASTM

0.20 inches minimum, plus 5 percent maximum

2.3.5 Density

2.3.4 Thickness

18.5 lbs/cu. ft. per ASTM D3574

2.4 ADHESIVES AND CONCRETE PRIMER

Comply with applicable regulations regarding toxic and hazardous materials. Provide water resistant, mildew resistant, nonflammable, and nonstaining adhesives and concrete primers for carpet installation as required by the carpet manufacturer. Provide adhesives flashpoint of minimum 140 degrees F in accordance with ASTM D3278.

Provide certification of indoor air quality for aerosol adhesives and sealants. Provide certification of indoor air quality for non-aerosol adhesives. Provide certification of indoor air quality for concrete primer.

2.5 MOLDINGS

Provide carpet moldings where floor covering material changes or carpet edge does not abut a vertical surface. Provide heavy-duty vinyl or rubber molding designed for the type of carpet being installed at all transitions unless noted otherwise.

2.6 COLOR, TEXTURE, AND PATTERN

Provide color, texture and pattern in accordance with the drawings and Interior Finish Schedule.

SECTION 099000 - PAINTING

PART 1 - GENERAL

1.1 RELATED DOCUMENTS

A. Drawings and general provisions of the Contract, including General and Supplementary Conditions and Division 01 Specification Sections, apply to this Section.

1.2 SUMMARY

A. Section includes surface preparation and the application of paint systems on the following

Concrete

interior substrates:

- Concrete masonry units (CMU).
- Galvanized metal.
- Wood. Gypsum board.

B. Related Requirements:

- Section 099300 "Staining and Transparent Finishing" for surface preparation and the application of wood stains and transparent finishes on interior wood substrates.
- Section 099600 "High Performance Coatings" for high-performance and special-use coatings.

1.3 DEFINITIONS

- A. Gloss Level 1: Not more than 5 units at 60 degrees and 10 units at 85 degrees, according to ASTM D 523.
- B. Gloss Level 2: Not more than 10 units at 60 degrees and 10 to 35 units at 85 degrees, according to ASTM D 523.

C. Gloss Level 3: 10 to 25 units at 60 degrees and 10 to 35 units at 85 degrees, according to

D. Gloss Level 4: 20 to 35 units at 60 degrees and not less than 35 units at 85 degrees, according

- to ASTM D 523.
- F. Gloss Level 6: 70 to 85 units at 60 degrees, according to ASTM D 523.

E. Gloss Level 5: 35 to 70 units at 60 degrees, according to ASTM D 523.


G. Gloss Level 7: More than 85 units at 60 degrees, according to ASTM D 523.

eyTingle nern G

M

口口口 BE

X

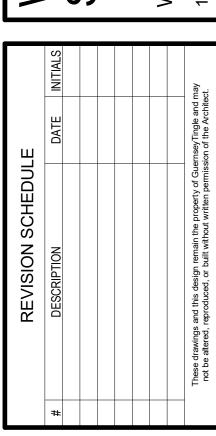

ARCHITECTURAL **SPECIFICATIONS**

> STEPHANIE L KALANTARIANS Lic. No. 013629 3/1/2024

Date: 3/1/2024 Drawn: TOG Checked: SLK Project: 223133

1.4 ACTION SUBMITTALS

- A. Product Data: For each type of product. Include preparation requirements and application
- B. Samples for Verification: For each type of paint system and in each color and gloss of topcoat.
 - Submit Samples on rigid backing, 8 inches square.
 - Step coats on Samples to show each coat required for system.
 - Label each coat of each Sample.
 - Label each Sample for location and application area.

C. Product List: For each product indicated, include the following:

- Cross-reference to paint system and locations of application areas.
- Use same designations indicated on Drawings and in schedules. Printout of current "MPI Approved Products List" for each product category specified in Part 2, with the proposed product highlighted.
- D. Coatings Inspection Report: Provide coatings inspection report as completed by authorized representative of selected coatings manufacturer. Report shall include photos of existing site conditions as well as product and surface preparation recommendations for all previously painted substrates.
- MAINTENANCE MATERIAL SUBMITTALS
- A. Furnish extra materials, from the same product run, that match products installed and that are packaged with protective covering for storage and identified with labels describing contents.
 - 1. Paint: 5 percent, but not less than 1 gallon of each material and color applied.
- B. Coating Maintenance Manual: Upon conclusion of the project, the Contractor or paint manufacturer/supplier shall furnish a coating maintenance manual, such as Sherwin-Williams "Custodian Project Color and Product Information" report or equal. Manual shall include an Area Summary with finish schedule, Area Detail designating where each product/color/finish was used, product data pages, Material Safety Data Sheets, care and cleaning instructions, touch-up procedures, and color samples of each color and finish used.
- DELIVERY, STORAGE, AND HANDLING
 - Store materials not in use in tightly covered containers in well-ventilated areas with
 - ambient temperatures continuously maintained at not less than 45 deg F. Maintain containers in clean condition, free of foreign materials and residue.
 - Remove rags and waste from storage areas daily.
- 1.7 FIELD CONDITIONS
- A. Apply paints only when temperature of surfaces to be painted and ambient air temperatures are between 50 and 95 deg F.
- B. Do not apply paints when relative humidity exceeds 85 percent; at temperatures less than 5 deg F above the dew point; or to damp or wet surfaces.

PART 2 - PRODUCTS

- 2.1 MANUFACTURERS
- A. Basis-of-Design:
 - 1. Sherwin-Williams Company (The). Matt Smith, Architectural Account Executive; (804)774-1967, matthew.a.smith@sherwin.com.
- B. Manufacturers: Subject to compliance with requirements, provide products by one of the
- PAINT, GENERAL
- A. MPI Standards: Provide products that comply with MPI standards indicated and that are listed in its "MPI Approved Products List."
- B. Material Compatibility:
- 1. Provide materials for use within each paint system that are compatible with one another and substrates indicated, under conditions of service and application as demonstrated by manufacturer, based on testing and field experience.
- 2. For each coat in a paint system, provide products recommended in writing by manufacturers of topcoat for use in paint system and on substrate indicated.
- C. Colors: As indicated in a color schedule.
 - 1. 20 percent of surface area will be painted with deep tones.
- 2.3 SOURCE QUALITY CONTROL
- A. Testing of Paint Materials: Owner reserves the right to invoke the following procedure:
 - Owner will engage the services of a qualified testing agency to sample paint materials. Contractor will be notified in advance and may be present when samples are taken. Ifpaint materials have already been delivered to Project site, samples may be taken at Project site. Samples will be identified, sealed, and certified by testing agency.
 - Testing agency will perform tests for compliance with product requirements. Owner may direct Contractor to stop applying coatings if test results show materials being used do not comply with product requirements. Contractor shall remove noncomplying paint materials from Project site, pay for testing, and repaint surfaces painted with rejected materials. Contractor will be required to remove rejected materials from previously painted surfaces if, on repainting with complying materials, the two paints are incompatible.

PAINTING 099000 - 3

PART 3 - EXECUTION

3.1 EXAMINATION

- A. Examine substrates and conditions, with Applicator present, for compliance with requirements for maximum moisture content and other conditions affecting performance of the Work.
- B. Maximum Moisture Content of Substrates: When measured with an electronic moisture meter
- Concrete: 12 percent.
- Masonry (Clay and CMU): 12 percent.
- Wood: 15 percent.
- Gypsum Board: 12 percent.
- C. Gypsum Board Substrates: Verify that finishing compound is sanded smooth.
- D. Verify suitability of substrates, including surface conditions and compatibility with existing finishes and primers.
- E. Mock-Up: Provide a mock-up for evaluation of surface preparation techniques and application workmanship.
 - Finish surfaces for verification of products, colors and sheens.
 - Finish area designated by Architect.
 - Provide samples that designate primer and finish coats.
 - Do not proceed with remaining work until the Architect approves the mock-up.
- F. Adhesion Test: Apply a test area on all previously painted substrates, allowing paint to dry one week before testing adhesion. If adhesion is poor, additional abrasion of the surface and/or removal of the previous coating may be necessary.
- G. Proceed with coating application only after unsatisfactory conditions have been corrected.
 - Application of coating indicates acceptance of surfaces and conditions.

3.2 PREPARATION

- A. Comply with manufacturer's written instructions and recommendations in "MPI Manual" applicable to substrates indicated.
- B. Remove hardware, covers, plates, and similar items already in place that are removable and are not to be painted. If removal is impractical or impossible because of size or weight of item, provide surface-applied protection before surface preparation and painting.
- 1. After completing painting operations, use workers skilled in the trades involved to reinstall items that were removed. Remove surface-applied protection if any.
- C. Clean substrates of substances that could impair bond of paints, including dust, dirt, oil, grease, and incompatible paints and encapsulants.
- D. Concrete Substrates: Remove release agents, curing compounds, efflorescence, and chalk. Do not paint surfaces if moisture content or alkalinity of surfaces to be painted exceeds that permitted in manufacturer's written instructions.
- Masonry Substrates: Remove efflorescence and chalk. Do not paint surfaces if moisture content or alkalinity of surfaces or mortar joints exceed that permitted in manufacturer's written instructions.
- F. Steel Substrates: Remove rust, loose mill scale, and shop primer, if any. Clean using methods recommended in writing by paint manufacturer.
- G. Shop-Primed Steel Substrates: Clean field welds, bolted connections, and abraded areas of shop paint, and paint exposed areas with the same material as used for shop priming to comply with SSPC-PA 1 for touching up shop-primed surfaces.
- H. Galvanized-Metal Substrates: Remove grease and oil residue from galvanized sheet metal fabricated from coil stock by mechanical methods to produce clean, lightly etched surfaces that promote adhesion of subsequently applied paints.
- I. Previously Painted Substrates: Apply a test area on all previously painted substrates, allowing paint to dry one week before testing adhesion. If adhesion is poor, additional abrasion of the surface and/or removal of the previous coating may be necessary.

3.3 APPLICATION

- Apply paints according to manufacturer's written instructions and to recommendations in
- Use applicators and techniques suited for paint and substrate indicated.
- Paint surfaces behind movable equipment and furniture same as similar exposed surfaces. Before final installation, paint surfaces behind permanently fixed equipment or furniture with prime coat only.
- Paint front and backsides of access panels, removable or hinged covers, and similar hinged items to match exposed surfaces.
- 4. Do not paint over labels of independent testing agencies or equipment name, identification, performance rating, or nomenclature plates.
- 5. Primers specified in painting schedules may be omitted on items that are factory primed or factory finished if acceptable to topcoat manufacturers.
- B. If undercoats or other conditions show through topcoat, apply additional coats until cured film has a uniform paint finish, color, and appearance.
- C. Apply paints to produce surface films without cloudiness, spotting, holidays, laps, brush marks, roller tracking, runs, sags, ropiness, or other surface imperfections. Cut in sharp lines and color breaks.
- D. Painting Fire Suppression, Plumbing, HVAC, Electrical, Communication, and Electronic Safety and Security Work:
 - 1. Paint the following work where exposed in equipment rooms:
 - Equipment, including panelboards and switch gear. Uninsulated metal piping.

PAINTING 099000 - 5

- c. Uninsulated plastic piping.
- d. Pipe hangers and supports.
- Metal conduit. Plastic conduit.
- Tanks that do not have factory-applied final finishes.
- Duct, equipment, and pipe insulation having cotton or canvas insulation covering or other paintable jacket material.
- Paint portions of internal surfaces of metal ducts, without liner, behind air inlets and outlets that are visible from occupied spaces.

FIELD QUALITY CONTROL

- Dry Film Thickness Testing: Owner may engage the services of a qualified testing and inspecting agency to inspect and test paint for dry film thickness.
- Contractor shall touch up and restore painted surfaces damaged by testing.
- If test results show that dry film thickness of applied paint does not comply with paint manufacturer's written recommendations, Contractor shall pay for testing and apply additional coats as needed to provide dry film thickness that complies with paint manufacturer's written recommendations.

CLEANING AND PROTECTION

- At end of each workday, remove rubbish, empty cans, rags, and other discarded materials
- After completing paint application, clean spattered surfaces. Remove spattered paints by washing, scraping, or other methods. Do not scratch or damage adjacent finished surfaces.
- C. Protect work of other trades against damage from paint application. Correct damage to work of other trades by cleaning, repairing, replacing, and refinishing, as approved by Architect,
- D. At completion of construction activities of other trades, touch up and restore damaged or defaced painted surfaces.

INTERIOR PAINTING SCHEDULE

and leave in an undamaged condition.

- A. CMU/Masonry Substrates:
 - Single-Component Epoxy System: Recoating of moderate traffic spaces.
 - Spot Prime LOXON Masonry Primer, LX2W0050 (bare or peeling masonry
 - Primer: Extreme Bond Primer, B51W1150
 - Intermediate Coat: Light industrial water based epoxy, matching topcoat. d. Eggshell Topcoat: Pro Industrial Pre-Catalyzed Water Based Epoxy Eg-Shel,
 - e. Semi-Gloss Topcoat: Pro Industrial Pre-Catalyzed Water Based Semi-Gloss,
- 2. Abrasion/Chemical Resistant Epoxy System: Previously painted high traffic wall surfaces - corridors, stairwells, columns, restrooms, gymnasium, locker rooms.
- Spot Prime LOXON Masonry Primer, LX2W0050 (bare or peeling masonry
- b. Primer: Extreme Bond Primer Interior/Exterior Bonding Primer, B51-1150
- c. Intermediate Coat: Epoxy-Modified Latex, Interior, matching topcoat. Eggshell Topcoat: Pro Industrial Water Based Catalyzed Epoxy Eg-Shel, B73-
- e. Gloss Topcoat: Pro Industrial Water Based Catalyzed Epoxy Gloss, B73-300
- Metal Substrates:
 - Water Based Alkyd System: Previously painted doors, frames, storefronts, window
 - Primer: Extreme Bond Primer Interior/Exterior Bonding Primer, B51-1150.
 - Intermediate Coat: Water Based Alkyd, Interior, matching topcoat.
- Gloss Topcoat: Pro Industrial Water Based Alkyd Urethane Semi-Gloss, B53-

C. Gypsum Board Substrates:

- Latex System:

 - Prime Coat: ProMar 200 Zero VOC Primer, B28W2600; MPI #149. Intermediate Coat: Latex, interior, institutional low odor/VOC, matching
- Flat Topcoat: ProMar 200 Zero VOC Latex Flat, B30-12650. Eggshell Topcoat: ProMar 200 HP Zero VOC Latex Eg-Shel, B20-1950.
- Semi-Gloss Topcoat: ProMar 200 HP Zero VOC Latex Semi-Gloss, B31-

D. Tile/Glazed Block Substrates:

- 1. Abrasion/Chemical Resistant Epoxy System:
 - Primer: Extreme Bond Primer Interior/Exterior Bonding Primer, B51-1150
- Intermediate Coat: Epoxy-Modified Latex, Interior, matching topcoat. c. Eggshell Topcoat: Pro Industrial Water Based Catalyzed Epoxy Eg-Shel, B73-
- d. Gloss Topcoat: Pro Industrial Water Based Catalyzed Epoxy Gloss, B73-300

EXTERIOR PAINTING SCHEDULE

- Concrete/Masonry Substrates:
- Acrylic System: Awnings.
- a. Primer: LOXON Masonry Primer, LX2W0050.
- Intermediate Coat: Pro Industrial Multi-Surface Acrylic Eg-Shel, B66-1560. Topcoat: Pro Industrial Multi-Surface Acrylic Eg-Shel, B66-1560.

PAINTING 099000 - 7

eyT U

MED S KELEY INISHE


BE

ARCHITECTURAL SPECIFICATIONS

> STEPHANIE L KALANTARIANS Lic. No. 013629 3/1/2024

Date: 3/1/2024 Drawn: TOG Checked: SLK

Project: 223133

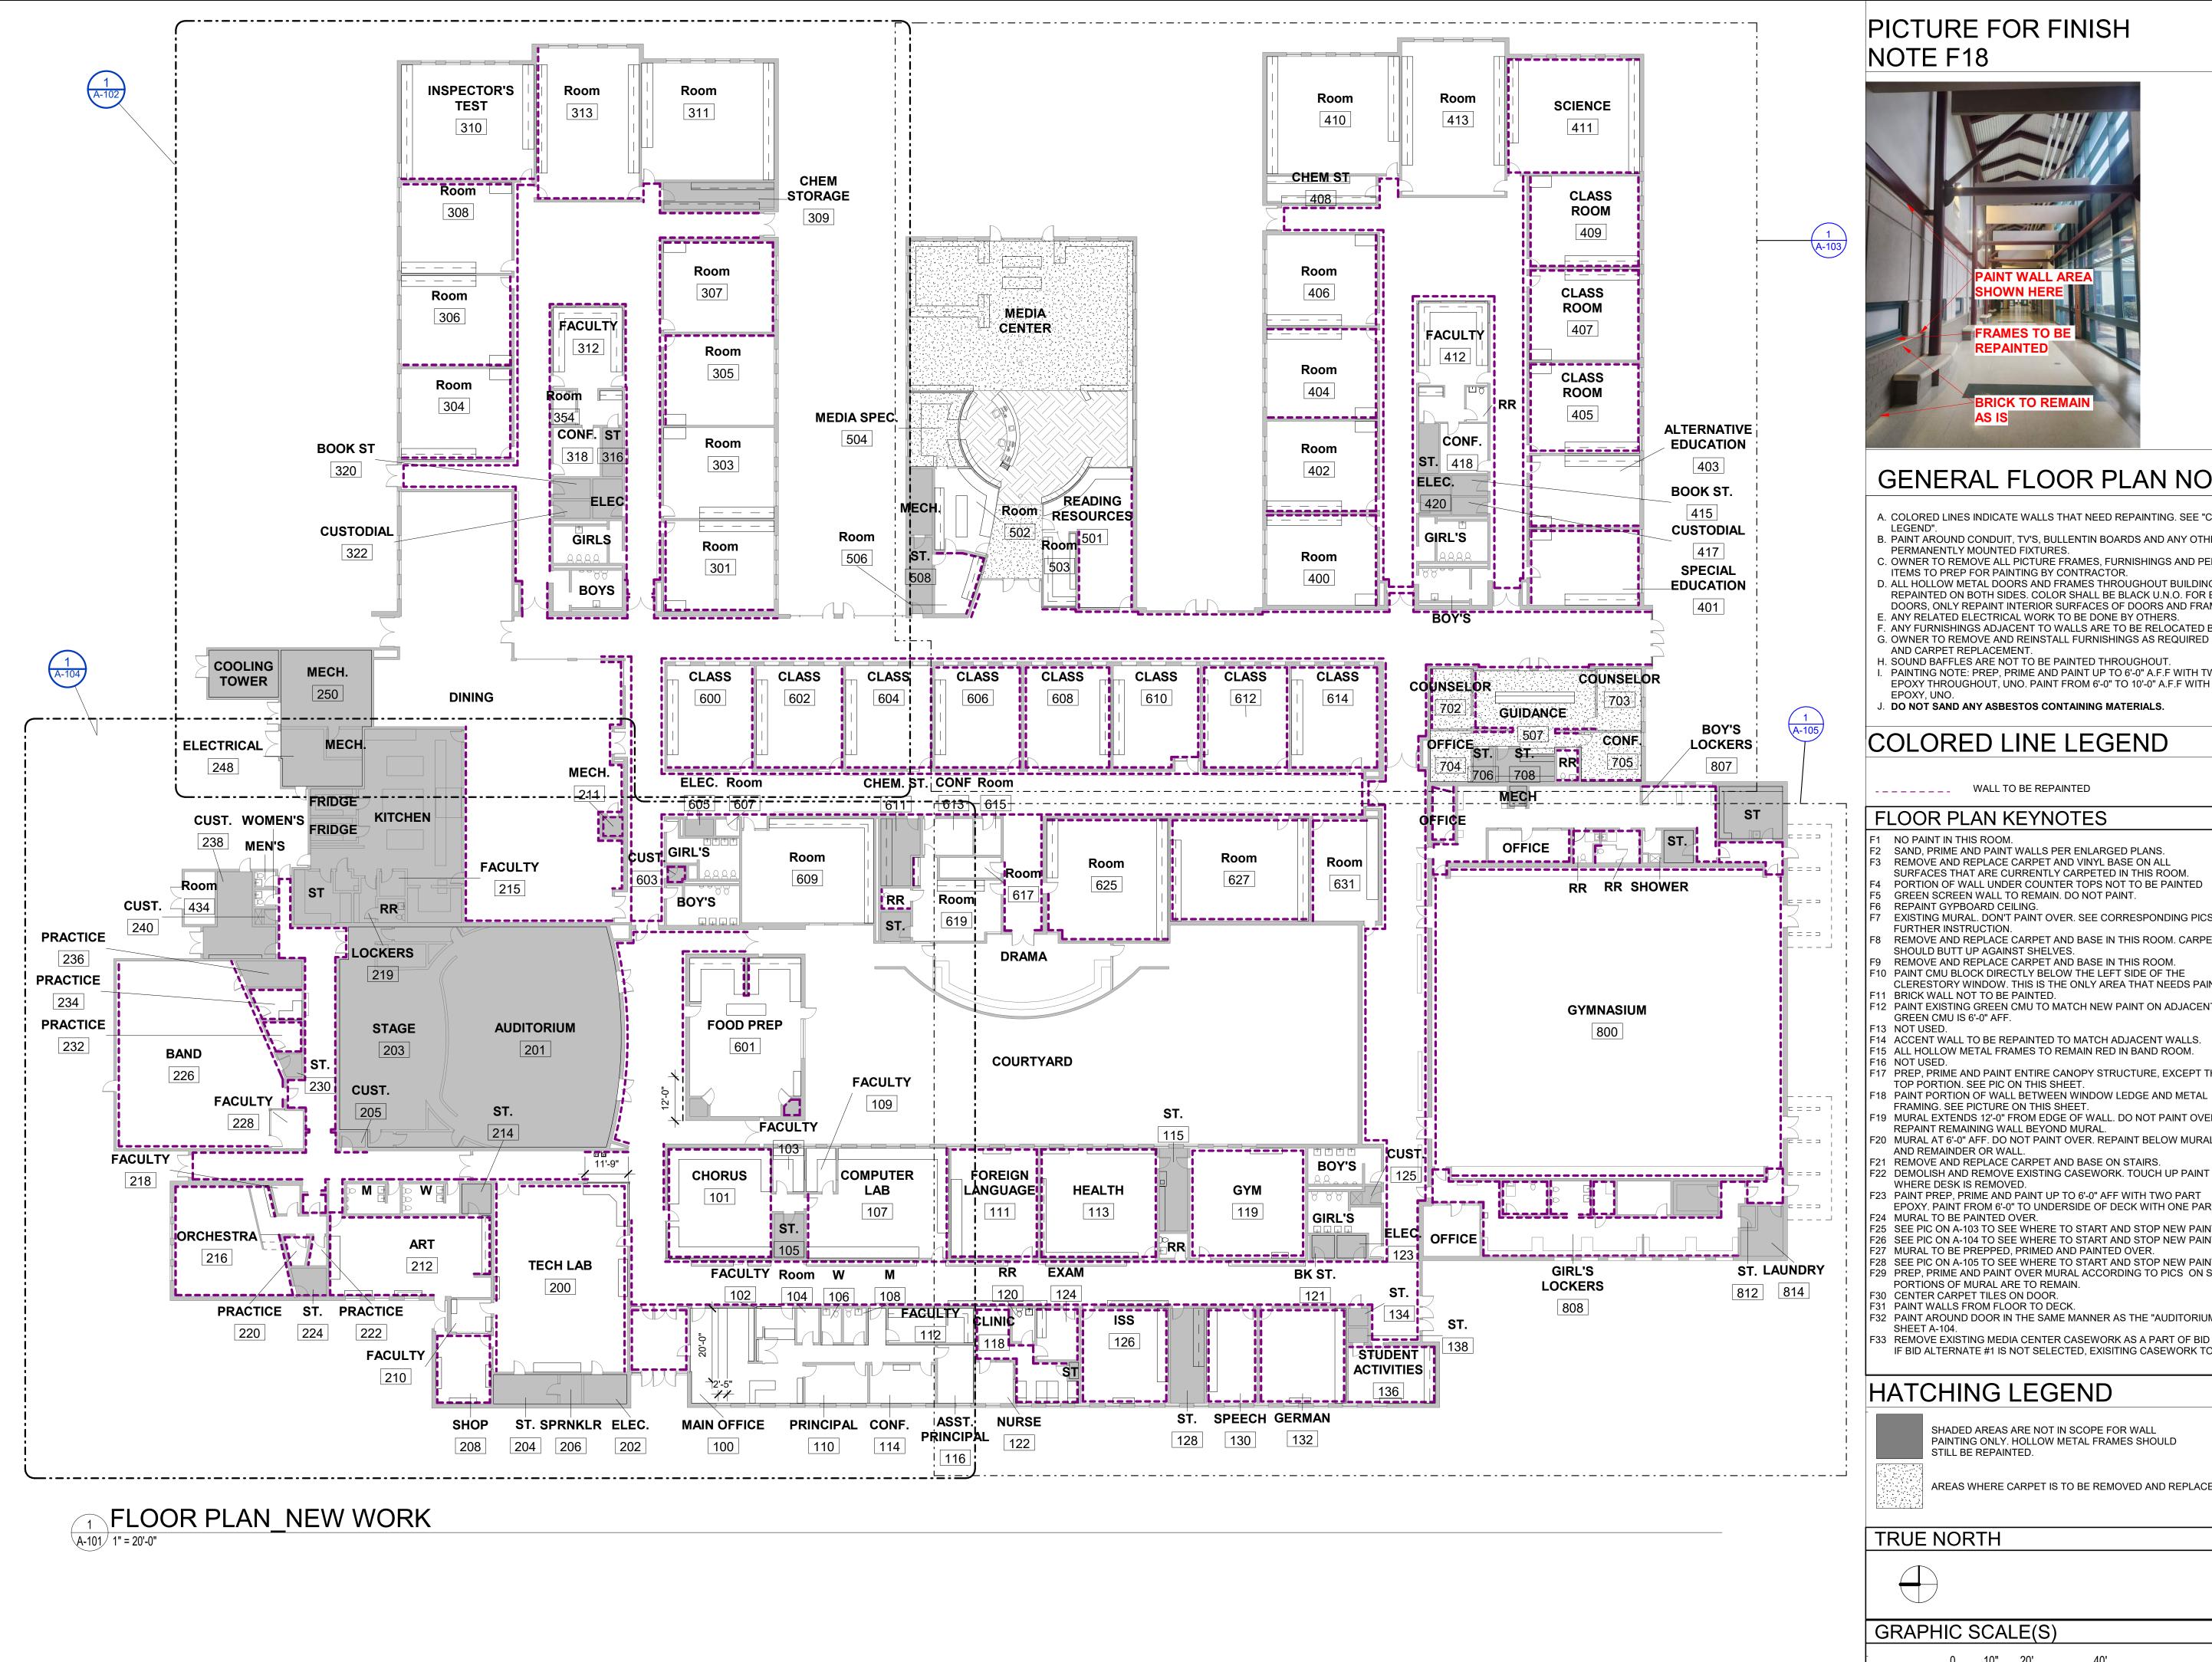

PICTURE FOR FINISH NOTE F18



GENERAL FLOOR PLAN NOTES

- B. PAINT AROUND CONDUIT, TV'S, BULLENTIN BOARDS AND ANY OTHER
- PERMANENTLY MOUNTED FIXTURES.
- C. OWNER TO REMOVE ALL PICTURE FRAMES, FURNISHINGS AND PERSONA ITEMS TO PREP FOR PAINTING BY CONTRACTOR
- . ANY FURNISHINGS ADJACENT TO WALLS ARE TO BE RELOCATED BY OWNER.
- AND CARPET REPLACEMENT. H. SOUND BAFFLES ARE NOT TO BE PAINTED THROUGHOUT
- PAINTING NOTE: PREP, PRIME AND PAINT UP TO 6'-0" A.F.F WITH TWO-PART EPOXY THROUGHOUT, UNO. PAINT FROM 6'-0" TO 10'-0" A.F.F WITH ONE-PART
- J. DO NOT SAND ANY ASBESTOS CONTAINING MATERIALS.

COLORED LINE LEGEND

WALL TO BE REPAINTED

FLOOR PLAN KEYNOTES

- NO PAINT IN THIS ROOM. SAND, PRIME AND PAINT WALLS PER ENLARGED PLANS.
- F3 REMOVE AND REPLACE CARPET AND VINYL BASE ON ALL SURFACES THAT ARE CURRENTLY CARPETED IN THIS ROOM.
- PORTION OF WALL UNDER COUNTER TOPS NOT TO BE PAINTED F5 GREEN SCREEN WALL TO REMAIN. DO NOT PAINT.
- F7 EXISTING MURAL. DON'T PAINT OVER. SEE CORRESPONDING PICS FOR
- FURTHER INSTRUCTION.
- F8 REMOVE AND REPLACE CARPET AND BASE IN THIS ROOM. CARPET SHOULD BUTT UP AGAINST SHELVES.
- F9 REMOVE AND REPLACE CARPET AND BASE IN THIS ROOM. F10 PAINT CMU BLOCK DIRECTLY BELOW THE LEFT SIDE OF THE
- CLERESTORY WINDOW. THIS IS THE ONLY AREA THAT NEEDS PAINT. 11 BRICK WALL NOT TO BE PAINTED.
- F12 PAINT EXISTING GREEN CMU TO MATCH NEW PAINT ON ADJACENT WALLS. GREEN CMU IS 6'-0" AFF.
- F14 ACCENT WALL TO BE REPAINTED TO MATCH ADJACENT WALLS. F15 ALL HOLLOW METAL FRAMES TO REMAIN RED IN BAND ROOM.
- F17 PREP, PRIME AND PAINT ENTIRE CANOPY STRUCTURE, EXCEPT THE TOP PORTION. SEE PIC ON THIS SHEET.
- FRAMING. SEE PICTURE ON THIS SHEET. F19 MURAL EXTENDS 12'-0" FROM EDGE OF WALL. DO NOT PAINT OVER.
- REPAINT REMAINING WALL BEYOND MURAL. F20 MURAL AT 6'-0" AFF. DO NOT PAINT OVER. REPAINT BELOW MURAL
- AND REMAINDER OR WALL. F21 REMOVE AND REPLACE CARPET AND BASE ON STAIRS.
- F22 DEMOLISH AND REMOVE EXISTING CASEWORK. TOUCH UP PAINT WHERE DESK IS REMOVED.
- F23 PAINT PREP, PRIME AND PAINT UP TO 6'-0" AFF WITH TWO PART EPOXY. PAINT FROM 6'-0" TO UNDERSIDE OF DECK WITH ONE PART EPOXY.
- F24 MURAL TO BE PAINTED OVER. F25 SEE PIC ON A-103 TO SEE WHERE TO START AND STOP NEW PAINT.
- F26 SEE PIC ON A-104 TO SEE WHERE TO START AND STOP NEW PAINT.
- F27 MURAL TO BE PREPPED, PRIMED AND PAINTED OVER.
- F28 SEE PIC ON A-105 TO SEE WHERE TO START AND STOP NEW PAINT. F29 PREP, PRIME AND PAINT OVER MURAL ACCORDING TO PICS ON SHEET A-104.
- F30 CENTER CARPET TILES ON DOOR.
- F31 PAINT WALLS FROM FLOOR TO DECK. F32 PAINT AROUND DOOR IN THE SAME MANNER AS THE "AUDITORIUM" PIC ON
- 33 REMOVE EXISTING MEDIA CENTER CASEWORK AS A PART OF BID ALTERNATE #1 IF BID ALTERNATE #1 IS NOT SELECTED, EXISITING CASEWORK TO REMAIN.

HATCHING LEGEND


SHADED AREAS ARE NOT IN SCOPE FOR WALL PAINTING ONLY. HOLLOW METAL FRAMES SHOULD STILL BE REPAINTED.

AREAS WHERE CARPET IS TO BE REMOVED AND REPLACED.

GRAPHIC SCALE(S)

G

 \Box

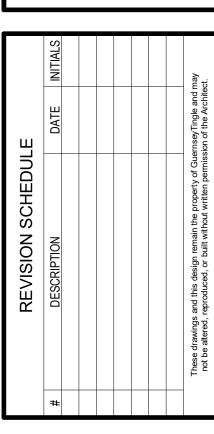

FLOOR PLAN - 1ST **FLOOR**

STEPHANIE L. KALANTARIANS Lic. No. 013629 3/1/2024

Date: 3/1/2024 Drawn: TOG Checked: SLK Project: 223133



GENERAL FLOOR PLAN NOTES

- A. COLORED LINES INDICATE WALLS THAT NEED REPAINTING. SEE "COLORED LINE
- B. PAINT AROUND CONDUIT, TV'S, BULLENTIN BOARDS AND ANY OTHER
- PERMANENTLY MOUNTED FIXTURES.
 C. OWNER TO REMOVE ALL PICTURE FRAMES, FURNISHINGS AND PERSONAL
- ITEMS TO PREP FOR PAINTING BY CONTRACTOR.

 D. ALL HOLLOW METAL DOORS AND FRAMES THROUGHOUT BUILDING TO BE REPAINTED ON BOTH SIDES. COLOR SHALL BE BLACK U.N.O. FOR EXTERIOR

DOORS, ONLY REPAINT INTERIOR SURFACES OF DOORS AND FRAMES.

- E. ANY RELATED ELECTRICAL WORK TO BE DONE BY OTHERS.F. ANY FURNISHINGS ADJACENT TO WALLS ARE TO BE RELOCATED BY OWNER.G. OWNER TO REMOVE AND REINSTALL FURNISHINGS AS REQUIRED FOR REPAINT
- H. SOUND BAFFLES ARE NOT TO BE PAINTED THROUGHOUT.
 I. PAINTING NOTE: PREP, PRIME AND PAINT UP TO 6'-0" A.F.F WITH TWO-PART EPOXY THROUGHOUT, UNO. PAINT FROM 6'-0" TO 10'-0" A.F.F WITH ONE-PART
- J. DO NOT SAND ANY ASBESTOS CONTAINING MATERIALS.

FLOOR PLAN KEYNOTES

AND CARPET REPLACEMENT.

- NO PAINT IN THIS ROOM.
- F2 SAND, PRIME AND PAINT WALLS PER ENLARGED PLANS.
 F3 REMOVE AND REPLACE CARPET AND VINYL BASE ON ALL SURFACES THAT ARE CURRENTLY CARPETED IN THIS ROOM.
- F4 PORTION OF WALL UNDER COUNTER TOPS NOT TO BE PAINTED GREEN SCREEN WALL TO REMAIN. DO NOT PAINT.
- F6 REPAINT GYPBOARD CEILING.
 F7 EXISTING MURAL. DON'T PAINT OVER. SEE CORRESPONDING PICS FOR
- FURTHER INSTRUCTION.
 F8 REMOVE AND REPLACE CARPET AND BASE IN THIS ROOM. CARPET SHOULD BUTT UP AGAINST SHELVES.
- F9 REMOVE AND REPLACE CARPET AND BASE IN THIS ROOM.
 F10 PAINT CMU BLOCK DIRECTLY BELOW THE LEFT SIDE OF THE
- F10 PAINT CMU BLOCK DIRECTLY BELOW THE LEFT SIDE OF THE CLERESTORY WINDOW. THIS IS THE ONLY AREA THAT NEEDS PAINT.
- F11 BRICK WALL NOT TO BE PAINTED.
 F12 PAINT EXISTING GREEN CMU TO MATCH NEW PAINT ON ADJACENT WALLS.
 GREEN CMU IS 6'-0" AFF.
- F13 NOT USED.
 F14 ACCENT WALL TO BE REPAINTED TO MATCH ADJACENT WALLS.
- F15 ALL HOLLOW METAL FRAMES TO REMAIN RED IN BAND ROOM. F16 NOT USED.
- F17 PREP, PRIME AND PAINT ENTIRE CANOPY STRUCTURE, EXCEPT THE TOP PORTION. SEE PIC ON THIS SHEET.

 F18 PAINT PORTION OF WALL BETWEEN WINDOW LEDGE AND METAL
- FRAMING. SEE PICTURE ON THIS SHEET.
 F19 MURAL EXTENDS 12'-0" FROM EDGE OF WALL. DO NOT PAINT OVER.
- REPAINT REMAINING WALL BEYOND MURAL.

 F20 MURAL AT 6'-0" AFF. DO NOT PAINT OVER. REPAINT BELOW MURAL
- AND REMAINDER OR WALL.

 F21 REMOVE AND REPLACE CARPET AND BASE ON STAIRS.
- F22 DEMOLISH AND REMOVE EXISTING CASEWORK. TOUCH UP PAINT WHERE DESK IS REMOVED.
- F23 PAINT PREP, PRIME AND PAINT UP TO 6'-0" AFF WITH TWO PART EPOXY. PAINT FROM 6'-0" TO UNDERSIDE OF DECK WITH ONE PART EPOXY. F24 MURAL TO BE PAINTED OVER.
- F25 SEE PIC ON A-103 TO SEE WHERE TO START AND STOP NEW PAINT. F26 SEE PIC ON A-104 TO SEE WHERE TO START AND STOP NEW PAINT.
- F27 MURAL TO BE PREPPED, PRIMED AND PAINTED OVER.
 F28 SEE PIC ON A-105 TO SEE WHERE TO START AND STOP NEW PAINT.
- F29 PREP, PRIME AND PAINT OVER MURAL ACCORDING TO PICS ON SHEET A-104.
 PORTIONS OF MURAL ARE TO REMAIN.
- F30 CENTER CARPET TILES ON DOOR. F31 PAINT WALLS FROM FLOOR TO DECK.
- F32 PAINT AROUND DOOR IN THE SAME MANNER AS THE "AUDITORIUM" PIC ON SHEET A-104
- F33 REMOVE EXISTING MEDIA CENTER CASEWORK AS A PART OF BID ALTERNATE #1. IF BID ALTERNATE #1 IS NOT SELECTED, EXISITING CASEWORK TO REMAIN.

COLORED LINE LEGEND - AREA A

WALL TO BE REPAINTED

FINISH LEGEND - AREA A



SHADED AREAS ARE NOT IN SCOPE FOR WALL PAINTING ONLY. HOLLOW METAL FRAMES SHOULD STILL BE REPAINTED.



MURAL TO BE

PAINTED OVER.

CPT-1





DO NOT PAINT OVER QUOTE.
OWNER TO PAINT BLACK
BORDER AROUND QUOTE.
PAINT OUTSIDE OF THAT
BORDER.

TRUE NORTH



GRAPHIC SCALE(S)

2" = 1' - 0"

STEPHANIE L.
KALANTARIANS
Lic. No. 013629

ENLARGED FLOOR PLAN - AREA A

ALTERATIONS

 $\mathsf{e}\mathsf{y}\mathsf{T}$

G

BE

Date: 3/1/2024
Drawn: TOG Checked: SLK
Project: 223133

3/1/2024

A-102

ENLARGED PLAN - AREA "A" ALTERATIONS

3/32" = 1'-0"

1 LINLAIXOLD I LAIN - AIXLA A-102 3/32" = 1'-0"



GENERAL FLOOR PLAN NOTES

- A. COLORED LINES INDICATE WALLS THAT NEED REPAINTING. SEE "COLORED LINE LEGEND".
- B. PAINT AROUND CONDUIT, TV'S, BULLENTIN BOARDS AND ANY OTHER
- PERMANENTLY MOUNTED FIXTURES.
 C. OWNER TO REMOVE ALL PICTURE FRAMES, FURNISHINGS AND PERSONAL
- ITEMS TO PREP FOR PAINTING BY CONTRACTOR.

 D. ALL HOLLOW METAL DOORS AND FRAMES THROUGHOUT BUILDING TO BE REPAINTED ON BOTH SIDES. COLOR SHALL BE BLACK U.N.O. FOR EXTERIOR
- DOORS, ONLY REPAINT INTERIOR SURFACES OF DOORS AND FRAMES.

 E. ANY RELATED ELECTRICAL WORK TO BE DONE BY OTHERS.

 F. ANY FURNISHINGS ADJACENT TO WALLS ARE TO BE RELOCATED BY OWNER.
- G. OWNER TO REMOVE AND REINSTALL FURNISHINGS AS REQUIRED FOR REPAINT AND CARPET REPLACEMENT.
- H. SOUND BAFFLES ARE NOT TO BE PAINTED THROUGHOUT.
 I. PAINTING NOTE: PREP, PRIME AND PAINT UP TO 6'-0" A.F.F WITH TWO-PART EPOXY THROUGHOUT, UNO. PAINT FROM 6'-0" TO 10'-0" A.F.F WITH ONE-PART
- EPOXY, UNO.

 J. DO NOT SAND ANY ASBESTOS CONTAINING MATERIALS.

FLOOR PLAN KEYNOTES

- F1 NO PAINT IN THIS ROOM.
 F2 SAND, PRIME AND PAINT WALLS PER ENLARGED PLANS.
- F3 REMOVE AND REPLACE CARPET AND VINYL BASE ON ALL SURFACES THAT ARE CURRENTLY CARPETED IN THIS ROOM.
- F4 PORTION OF WALL UNDER COUNTER TOPS NOT TO BE PAINTED
- F5 GREEN SCREEN WALL TO REMAIN. DO NOT PAINT. F6 REPAINT GYPBOARD CEILING.
- F7 EXISTING MURAL. DON'T PAINT OVER. SEE CORRESPONDING PICS FOR FURTHER INSTRUCTION.
- F8 REMOVE AND REPLACE CARPET AND BASE IN THIS ROOM. CARPET SHOULD BUTT UP AGAINST SHELVES.
 F9 REMOVE AND REPLACE CARPET AND BASE IN THIS ROOM.
- F10 PAINT CMU BLOCK DIRECTLY BELOW THE LEFT SIDE OF THE CLERESTORY WINDOW. THIS IS THE ONLY AREA THAT NEEDS PAINT.
- F11 BRICK WALL NOT TO BE PAINTED.
 F12 PAINT EXISTING GREEN CMU TO MATCH NEW PAINT ON ADJACENT WALLS.
- GREEN CMU IS 6'-0" AFF.
- F13 NOTUSED.

 F14 ACCENT WALL TO BE REPAINTED TO MATCH ADJACENT WALLS.
- F15 ALL HOLLOW METAL FRAMES TO REMAIN RED IN BAND ROOM.
- F17 PREP, PRIME AND PAINT ENTIRE CANOPY STRUCTURE, EXCEPT THE
- TOP PORTION. SEE PIC ON THIS SHEET.

 F18 PAINT PORTION OF WALL BETWEEN WINDOW LEDGE AND METAL FRAMING. SEE PICTURE ON THIS SHEET.
- F19 MURAL EXTENDS 12'-0" FROM EDGE OF WALL. DO NOT PAINT OVER. REPAINT REMAINING WALL BEYOND MURAL.
- F20 MURAL AT 6'-0" AFF. DO NOT PAINT OVER. REPAINT BELOW MURAL AND REMAINDER OR WALL.
- F21 REMOVE AND REPLACE CARPET AND BASE ON STAIRS.
 F22 DEMOLISH AND REMOVE EXISTING CASEWORK. TOUCH UP PAINT
- WHERE DESK IS REMOVED.

 F23 PAINT PREP, PRIME AND PAINT UP TO 6'-0" AFF WITH TWO PART

 FROM COMMENT FROM COMM
- EPOXY. PAINT FROM 6'-0" TO UNDERSIDE OF DECK WITH ONE PART EPOXY.
 F24 MURAL TO BE PAINTED OVER.
- F25 SEE PIC ON A-103 TO SEE WHERE TO START AND STOP NEW PAINT.
- F26 SEE PIC ON A-104 TO SEE WHERE TO START AND STOP NEW PAINT.
 F27 MURAL TO BE PREPPED, PRIMED AND PAINTED OVER.
- F28 SEE PIC ON A-105 TO SEE WHERE TO START AND STOP NEW PAINT.
 F29 PREP, PRIME AND PAINT OVER MURAL ACCORDING TO PICS ON SHEET A-104.
- PORTIONS OF MURAL ARE TO REMAIN.

 F30 CENTER CARPET TILES ON DOOR.
- F30 CENTER CARPET TILES ON DOOR. F31 PAINT WALLS FROM FLOOR TO DECK.
- F32 PAINT AROUND DOOR IN THE SAME MANNER AS THE "AUDITORIUM" PIC ON SHEET A-104.
- F33 REMOVE EXISTING MEDIA CENTER CASEWORK AS A PART OF BID ALTERNATE #1 IF BID ALTERNATE #1 IS NOT SELECTED, EXISITING CASEWORK TO REMAIN.

COLORED LINE LEGEND - AREA B


WALL TO BE REPAINTED

FINISH LEGEND - AREA B

SHADED AREAS ARE NOT IN SCOPE FOR WALL PAINTING ONLY. HOLLOW METAL FRAMES SHOULD STILL BE REPAINTED.

©PT-1

CPT-2

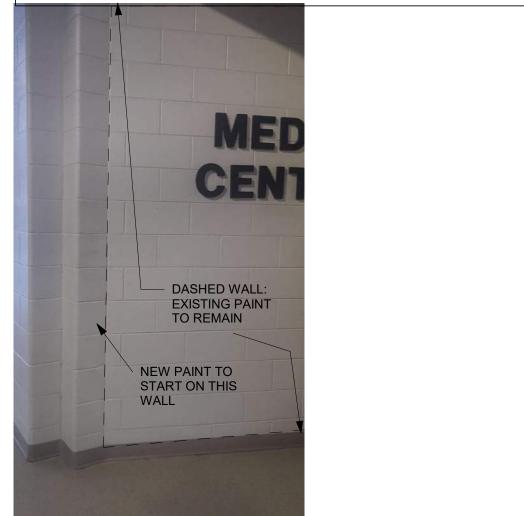

TRUE NORTH



GRAPHIC SCALE(S)

32" = 1' - 0"

ENLARGED FLOOR PLAN - AREA B ALTERATIONS

BE

 $\mathsf{e}\mathsf{y}\mathsf{T}$

G

STEPHANIE L.
KALANTARIANS
Lic. No. 013629

Date: 3/1/2024

Drawn: TOG Checked: SLK

Project: 223133



uernseyTingle
7-220-0220 Williamsburg, VA
guernseytingle.com

U

S BERKELEY MIDDLE JOL FINISHES

ENLARGED FLOOR PLAN - AREA C ALTERATIONS

STEPHANIE L.
KALANTARIANS
Lic. No. 013629

3/1/2024

ARCHITECT

Date: 3/1/2024
Drawn: TOG Checked: SLK
Project: 223133



PAINT ALL SURFACES OF CANOPY EXCEPT THE TOP. PAINT FROM THE

PIC REFERENCING NOTE F17

GENERAL FLOOR PLAN NOTES

- A. COLORED LINES INDICATE WALLS THAT NEED REPAINTING. SEE "COLORED LINE
- B. PAINT AROUND CONDUIT, TV'S, BULLENTIN BOARDS AND ANY OTHER
- PERMANENTLY MOUNTED FIXTURES. C. OWNER TO REMOVE ALL PICTURE FRAMES, FURNISHINGS AND PERSONAL ITEMS TO PREP FOR PAINTING BY CONTRACTOR.
- D. ALL HOLLOW METAL DOORS AND FRAMES THROUGHOUT BUILDING TO BE REPAINTED ON BOTH SIDES. COLOR SHALL BE BLACK U.N.O. FOR EXTERIOR
- DOORS, ONLY REPAINT INTERIOR SURFACES OF DOORS AND FRAMES. E. ANY RELATED ELECTRICAL WORK TO BE DONE BY OTHERS. F. ANY FURNISHINGS ADJACENT TO WALLS ARE TO BE RELOCATED BY OWNER. G. OWNER TO REMOVE AND REINSTALL FURNISHINGS AS REQUIRED FOR REPAINT
- AND CARPET REPLACEMENT. H. SOUND BAFFLES ARE NOT TO BE PAINTED THROUGHOUT. I. PAINTING NOTE: PREP, PRIME AND PAINT UP TO 6'-0" A.F.F WITH TWO-PART EPOXY THROUGHOUT, UNO. PAINT FROM 6'-0" TO 10'-0" A.F.F WITH ONE-PART
- J. DO NOT SAND ANY ASBESTOS CONTAINING MATERIALS.

FLOOR PLAN KEYNOTES

- F1 NO PAINT IN THIS ROOM. F2 SAND, PRIME AND PAINT WALLS PER ENLARGED PLANS.
- F3 REMOVE AND REPLACE CARPET AND VINYL BASE ON ALL SURFACES THAT ARE CURRENTLY CARPETED IN THIS ROOM.
- PORTION OF WALL UNDER COUNTER TOPS NOT TO BE PAINTED F5 GREEN SCREEN WALL TO REMAIN. DO NOT PAINT.
- F7 EXISTING MURAL. DON'T PAINT OVER. SEE CORRESPONDING PICS FOR
- FURTHER INSTRUCTION. F8 REMOVE AND REPLACE CARPET AND BASE IN THIS ROOM. CARPET
- SHOULD BUTT UP AGAINST SHELVES. REMOVE AND REPLACE CARPET AND BASE IN THIS ROOM. F10 PAINT CMU BLOCK DIRECTLY BELOW THE LEFT SIDE OF THE
- CLERESTORY WINDOW. THIS IS THE ONLY AREA THAT NEEDS PAINT. 1 BRICK WALL NOT TO BE PAINTED.
- F12 PAINT EXISTING GREEN CMU TO MATCH NEW PAINT ON ADJACENT WALLS. GREEN CMU IS 6'-0" AFF.
- F14 ACCENT WALL TO BE REPAINTED TO MATCH ADJACENT WALLS.
- F15 ALL HOLLOW METAL FRAMES TO REMAIN RED IN BAND ROOM. F16 NOT USED.
- F17 PREP, PRIME AND PAINT ENTIRE CANOPY STRUCTURE, EXCEPT THE TOP PORTION. SEE PIC ON THIS SHEET.
- F18 PAINT PORTION OF WALL BETWEEN WINDOW LEDGE AND METAL FRAMING. SEE PICTURE ON THIS SHEET. F19 MURAL EXTENDS 12'-0" FROM EDGE OF WALL. DO NOT PAINT OVER.
- REPAINT REMAINING WALL BEYOND MURAL. F20 MURAL AT 6'-0" AFF. DO NOT PAINT OVER. REPAINT BELOW MURAL
- AND REMAINDER OR WALL. F21 REMOVE AND REPLACE CARPET AND BASE ON STAIRS.
- F22 DEMOLISH AND REMOVE EXISTING CASEWORK. TOUCH UP PAINT WHERE DESK IS REMOVED.
- F23 PAINT PREP, PRIME AND PAINT UP TO 6'-0" AFF WITH TWO PART EPOXY. PAINT FROM 6'-0" TO UNDERSIDE OF DECK WITH ONE PART EPOXY.
- F24 MURAL TO BE PAINTED OVER. F25 SEE PIC ON A-103 TO SEE WHERE TO START AND STOP NEW PAINT. F26 SEE PIC ON A-104 TO SEE WHERE TO START AND STOP NEW PAINT.
- F27 MURAL TO BE PREPPED, PRIMED AND PAINTED OVER. F28 SEE PIC ON A-105 TO SEE WHERE TO START AND STOP NEW PAINT.
- F29 PREP, PRIME AND PAINT OVER MURAL ACCORDING TO PICS ON SHEET A-104.
- PORTIONS OF MURAL ARE TO REMAIN. F30 CENTER CARPET TILES ON DOOR.
- F31 PAINT WALLS FROM FLOOR TO DECK. F32 PAINT AROUND DOOR IN THE SAME MANNER AS THE "AUDITORIUM" PIC ON
- F33 REMOVE EXISTING MEDIA CENTER CASEWORK AS A PART OF BID ALTERNATE #1. IF BID ALTERNATE #1 IS NOT SELECTED, EXISITING CASEWORK TO REMAIN.

COLORED LINE LEGEND - AREA D

FINISH LEGEND - AREA D

SHADED AREAS ARE NOT IN SCOPE FOR WALL PAINTING ONLY. HOLLOW METAL FRAMES SHOULD STILL BE REPAINTED.

DASHED AREA: EXISTING PAINT NEW PAINT TO START ON THIS WALL. TO REMAIN REAPEAT ON BOTH SIDES OF THIS DOOR AND ON THE ADJACENT GYMNASIUM DOOR.

TRUE NORTH

eyTingle U

MIDDLI BERKELEY OL FINISHES

ENLARGED FLOOR PLAN - AREA D ALTERATIONS

STEPHANIE L. KALANTARIANS Lic. No. 013629 3/1/2024


Date: 3/1/2024 Drawn: TOG Checked: SLK Project: 223133

A-105

GRAPHIC SCALE(S)

A-105 3/32" = 1'-0"

ENLARGED FLOOR PLAN - AREA D ALTERATIONS

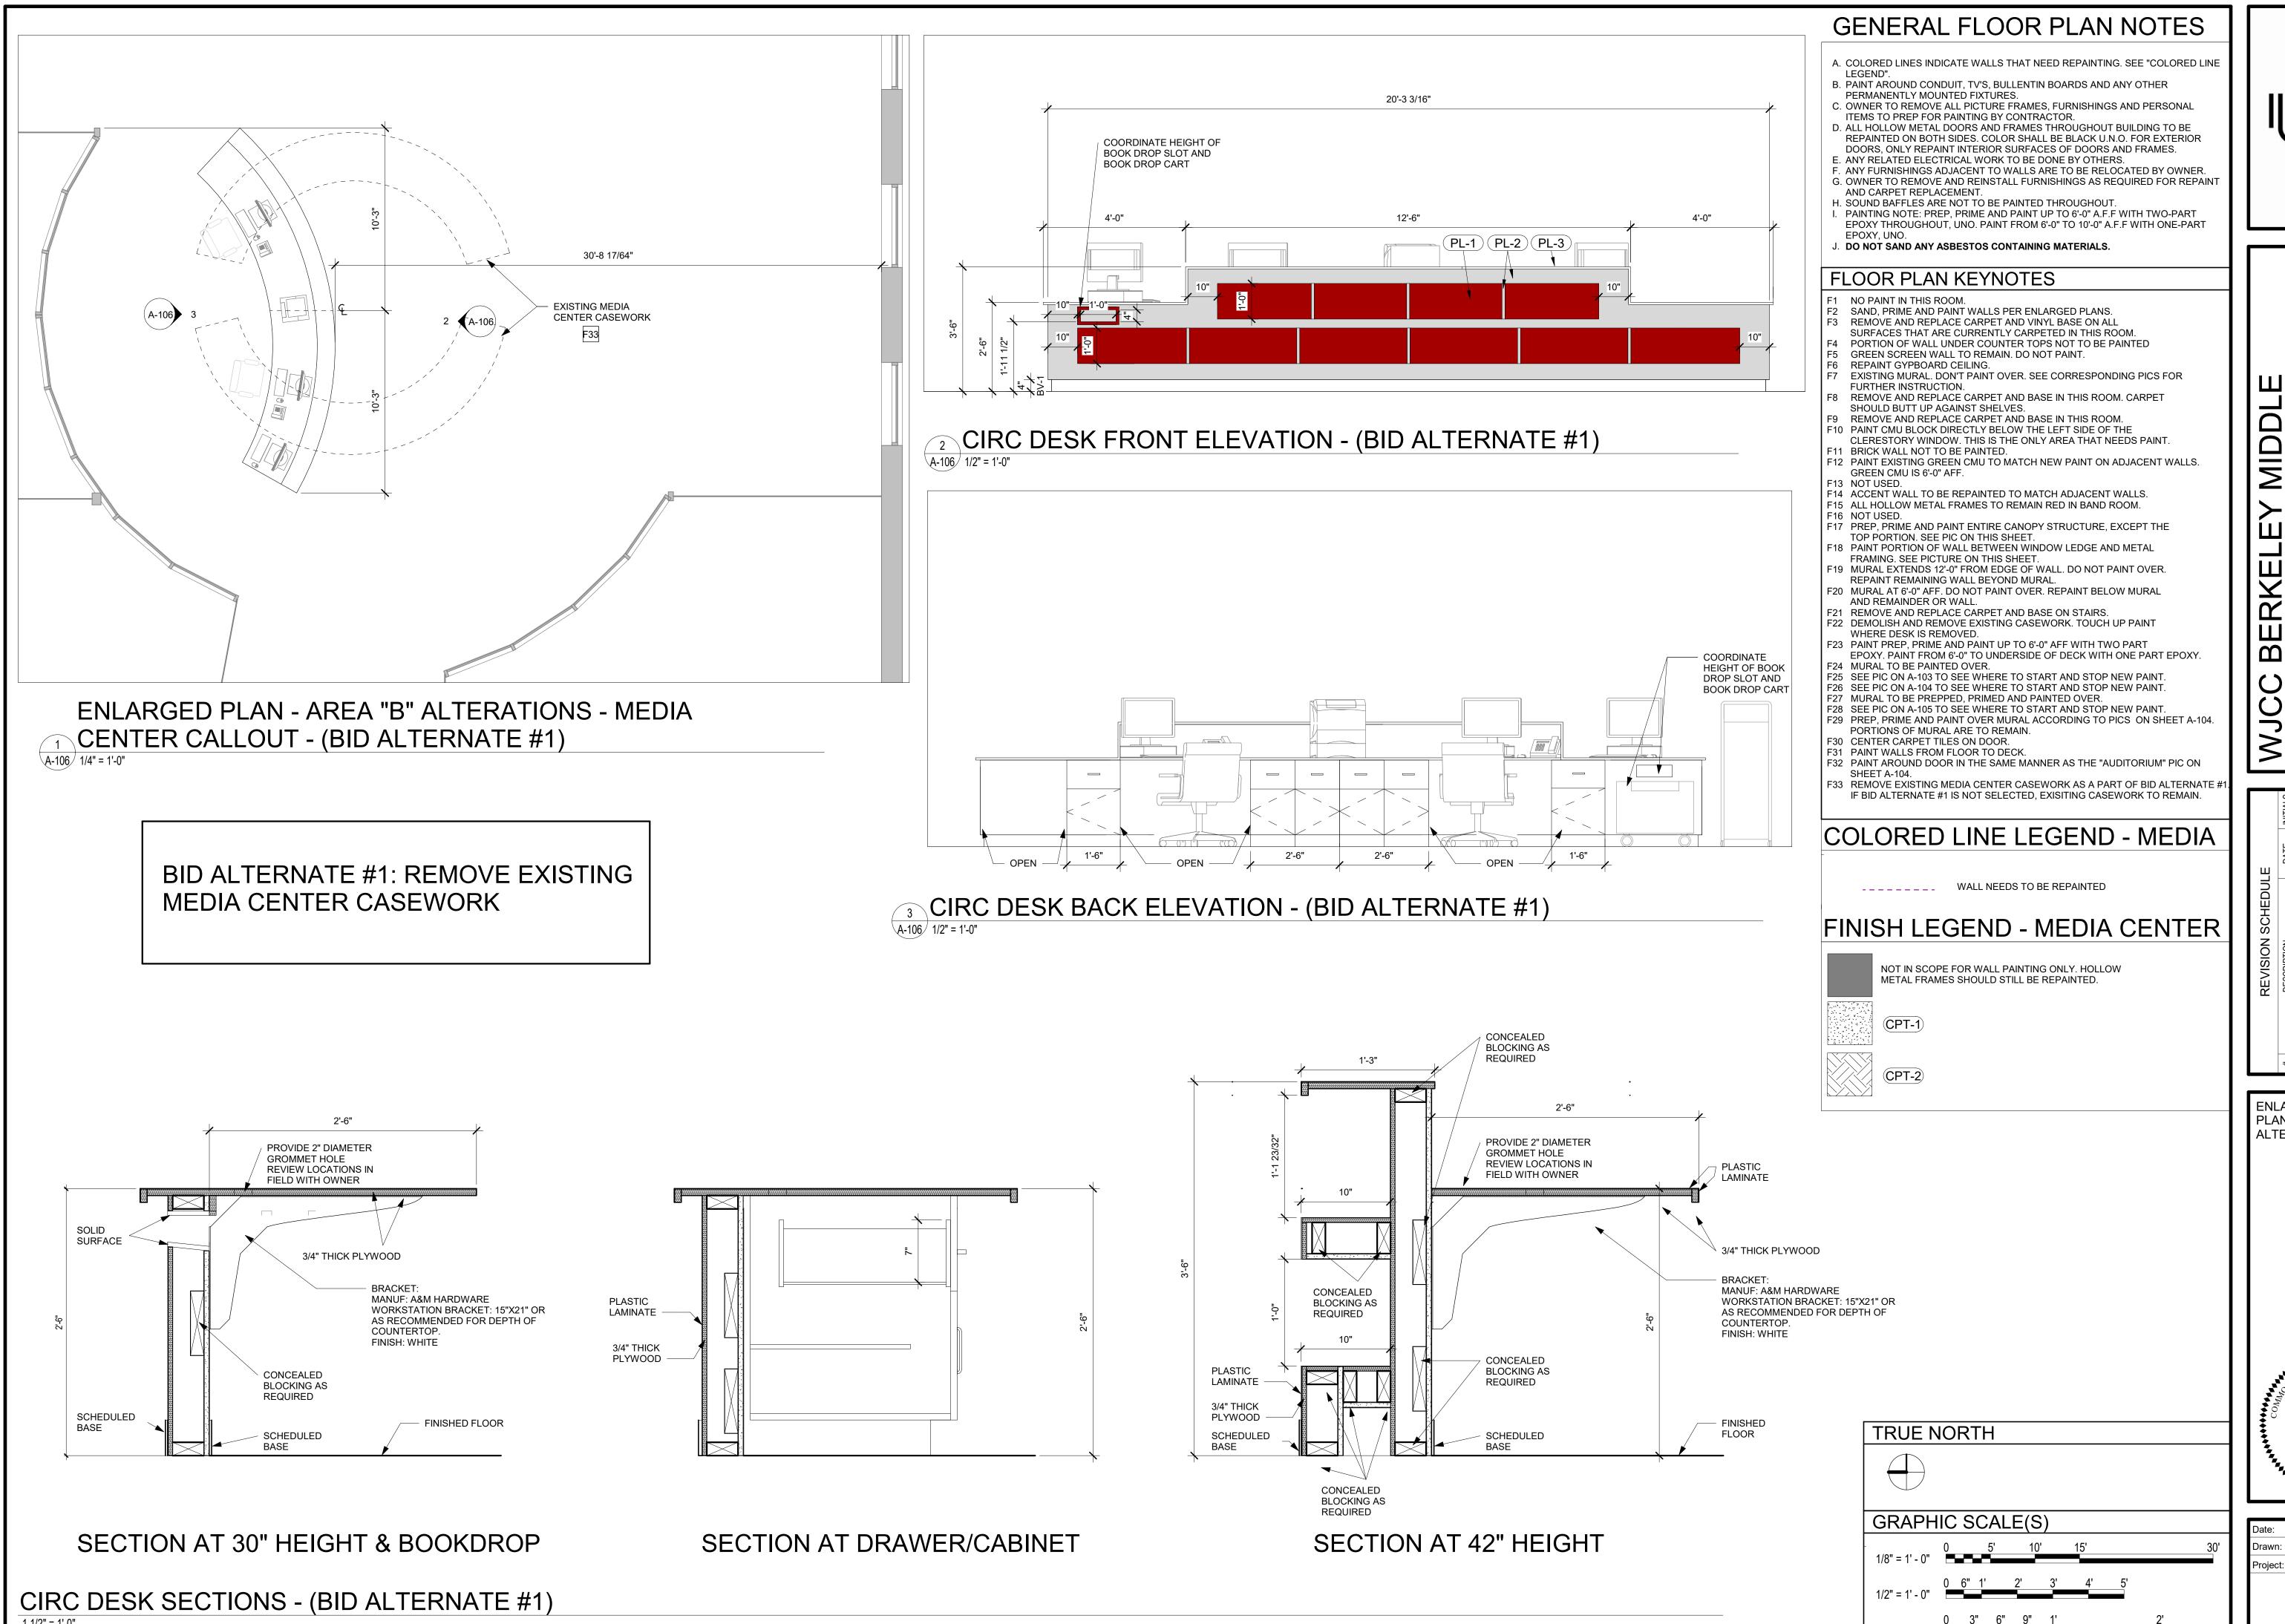

GuernseyTingle
757-220-0220 Williamsburg, VA

C BERKELEY MIDDLE 100L FINISHES

DESCRIPTION SCHEDULE INITIALS


These drawings and this design remain the property of Guernsey/Tingle and may not be altered, reproduced, or built without written permission of the Architect.

ENLARGED FLOOR PLAN - MEDIA CENTER ALTERATIONS

STEPHANIE L.
KALANTARIANS
Lic. No. 013629

3/1/2024

Date: 3/1/2024
Drawn: TOG Checked: SLK
Project: 223133

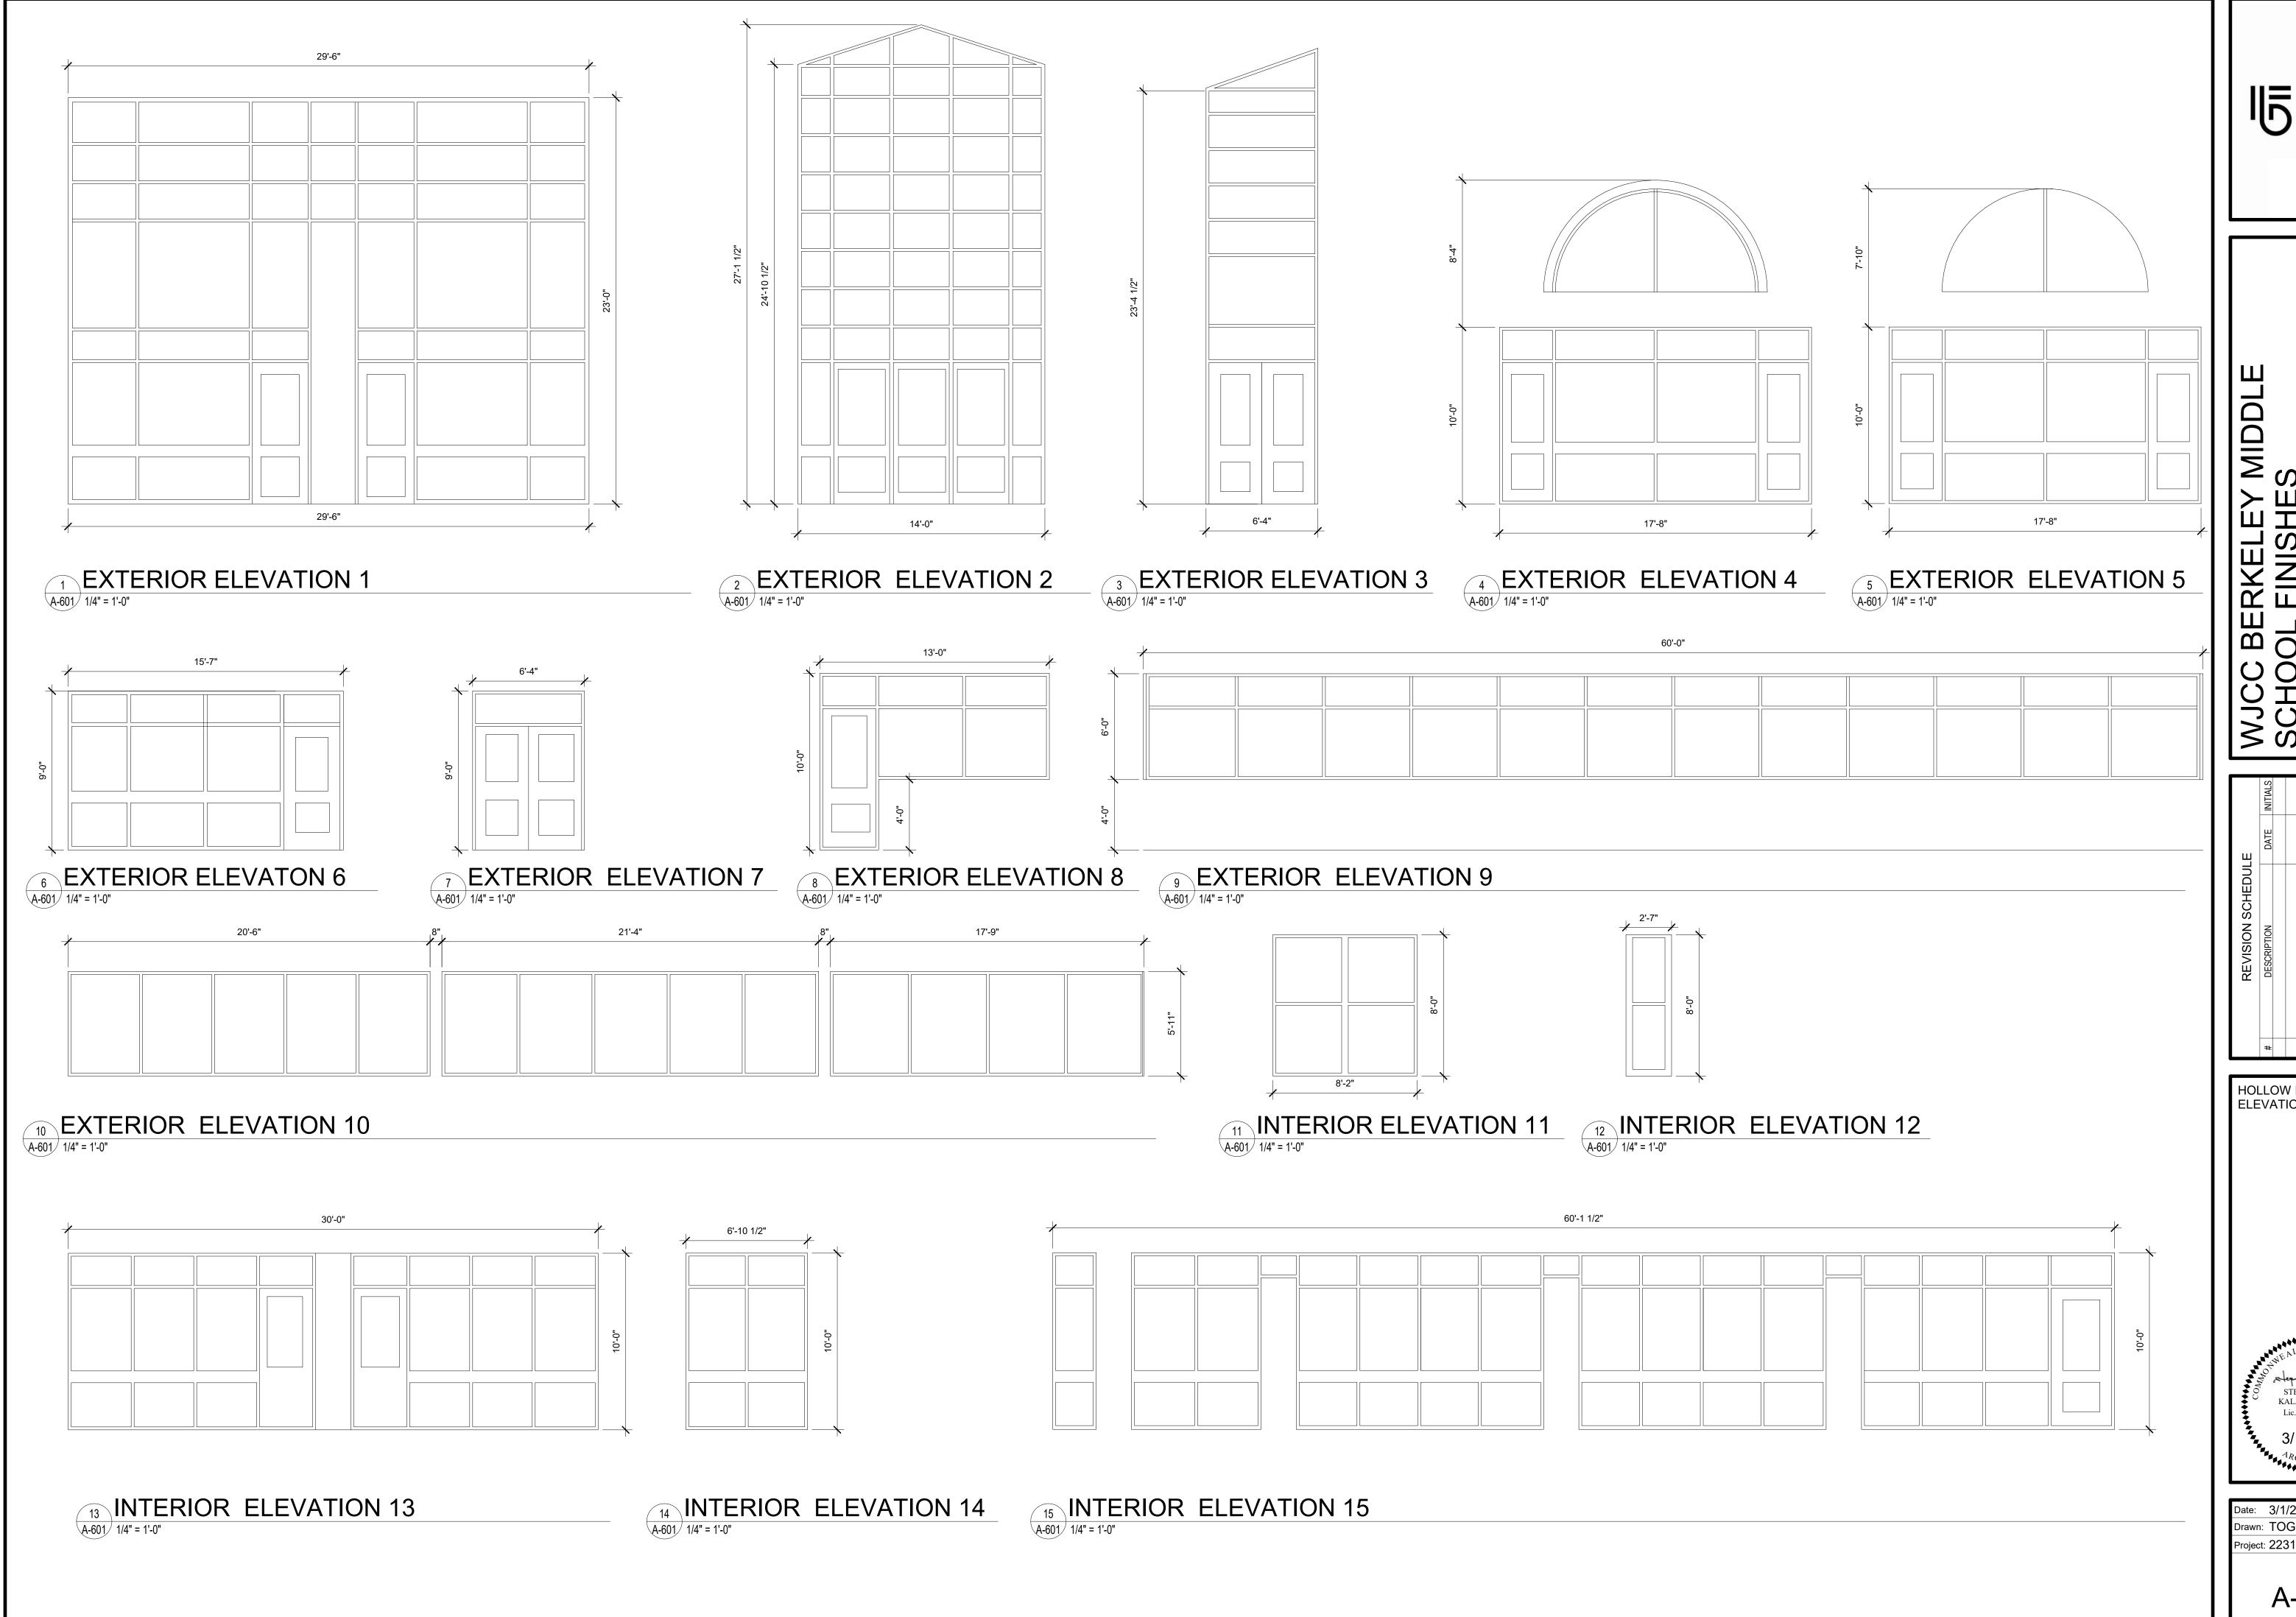


GuernseyTingle

HOLLOW METAL FRAME ELEVATIONS & DETAILS


STEPHANIE L. KALANTARIANS Lic. No. 013629 3/1/2024

Date: 3/1/2024 Drawn: TOG Checked: SLK Project: 223133

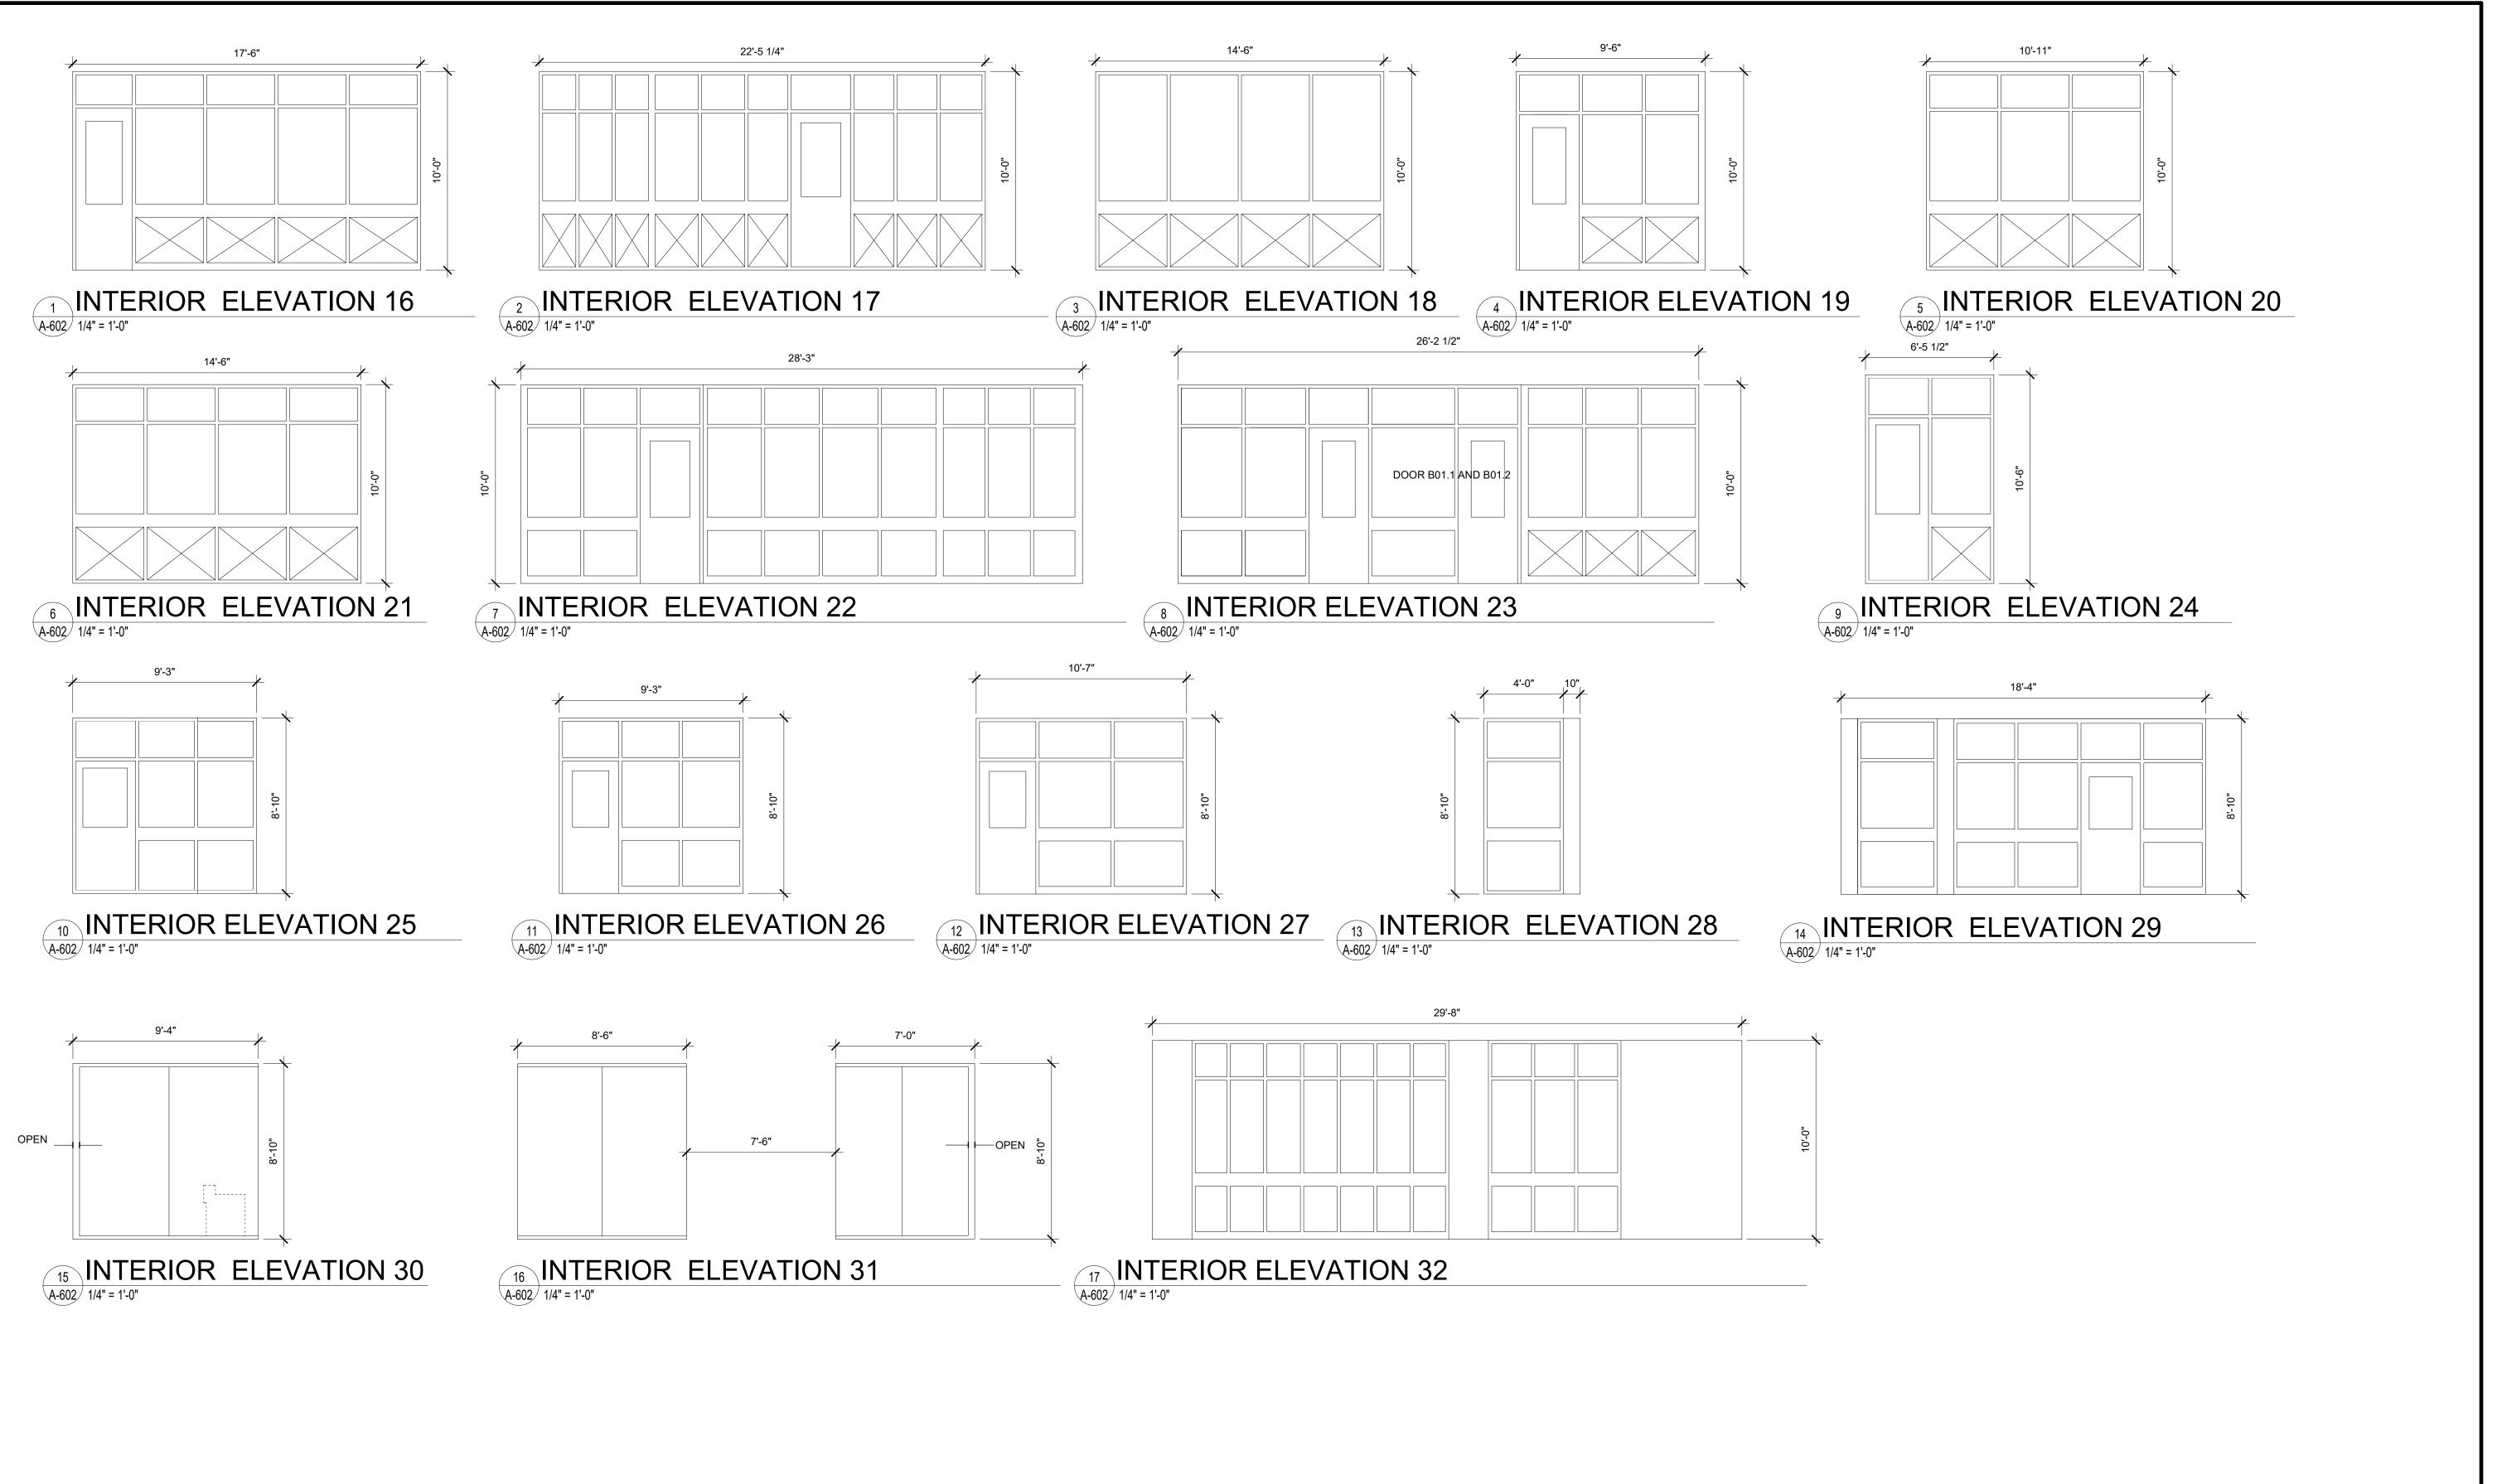


GuernseyTingle
757-220-0220 Williamsburg, VA
guernseytingle.com

WJCC BERKELEY MIDDLE SCHOOL FINISHES

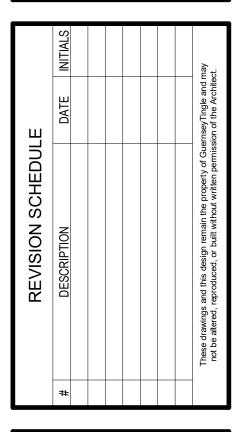

HOLLOW METAL FRAME ELEVATIONS & DETAILS

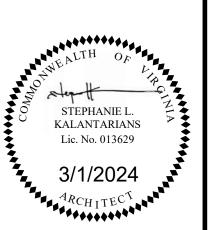

Date: 3/1/2024

Drawn: TOG Checked: SLK

Project: 223133

FINISH SCHEDULE								
#	MATERIAL	MANUFACTURER	STYLE/COLOR	CONTACT	REMARKS			
CPT-1	CARPET TILE - FIELD	SHAW CONTRACT	DIFFUSE COLOR + DISPERSE COLOR COLOR TBD	DEBORAH CREAMER 757-635-7749				
CPT-2	CARPET TILE - ACCENT	SHAW CONTRACT	DIFFUSE COLOR + DISPERSE COLOR COLOR TBD	DEBORAH CREAMER 757-635-7749				
BV-1	VINYL BASE	JOHNSONITE	TBD	BILL MORGAN 804-382-6317	4" COVE BASE			
PL-1	PLASTIC LAMINATE	FORMICA	NEW BURGUNDY 7966-58	MATTE FINISH	BID ALT FOR MEDIA CENTER CASEWORK BOOK CUBBIES			
PL-2	PLASTIC LAMINATE	FORMICA	STORM 912-ML	MONOLITH FINISH	BID ALT FOR MEDIA CENTER CASEWORK FACE OF CASEWORK			
PL-3	PLASTIC LAMINATE	FORMICA	SUGAR GLASS 3705-58	MATTE FINISH	BID ALT FOR MEDIA CENTER CASEWORK COUNTER			
PT-1	PAINT - FIELD	SHERWIN WILLIAMS	SW2832 COLONIAL REVIVAL GRAY	CASEY GIBSON 757-592-8384	SEE FINISH PLAN GENERAL NOTE #13 FOR PAINT SHEEN			
PT-2	PAINT - CEILING	SHERWIN WILLIAMS	SW7004 SNOWBOUND	CASEY GIBSON 757-592-8384	SEE FINISH PLAN GENERAL NOTE #13 FOR PAINT SHEEN			
PT-3	PAINT - STOREFRONT	SHERWIN WILLIAMS	SW6258 TRICORN BLACK	CASEY GIBSON 757-592-8384	SEE FINISH PLAN GENERAL NOTE #13 FOR PAINT SHEEN			

FINISH PLAN GENERAL NOTES

1. ALL INTERIOR FINISH SPECIFICATIONS ARE INCLUDED HEREIN OR IN THE ATTACHED SPECIFICATIONS, IF APPLICABLE. DISCREPANCIES, OMISSIONS, AND DISCONTINUED OR DELAYED MATERIALS ARE TO BE REPORTED TO THE DESIGNER IMMEDIATELY FOR RESOLUTION PRIOR TO PROCEEDING. THE DESIGNER IS NOT RESPONSIBLE FOR DISCREPANCIES OF OMISSIONS THAT ARISE DUE TO CHANGES BY ANOTHER PARTY AFTER ORIGINAL DRAWING ISSUANCE DATE UNLESS RECORDED AS A REVISION BY GTA.

2. SUBMIT SAMPLES OF ALL FINISH MATERIALS TO THE DESIGNER FOR APPROVAL PRIOR TO COMMENCING WORK. SUBMIT ACTUAL COLOR AND FINISH OF PAINT. SAMPLES OF NATURAL STONE OR OTHER MATERIALS WITH WIDE COLOR VARIATIONS SHALL COME FROM ACTUAL MATERIAL TO BE USED.

3. INSTALL ALL FINISH MATERIALS ACCORDING TO MANUFACTURER'S INSTRUCTIONS.

4. ONLY ONE DYE-LOT OF EACH STYLE AND COLOR SPECIFIED IN THE FINISH SCHEDULE SHALL BE USED.

5. REMOVE FINISH MATERIALS FROM PACKAGING AND ALLOW TO ACCLIMATIZE TO AREA OF INSTALLATION ACCORDING TO MANUFACTURER'S INSTRUCTIONS.

6. ALL SURFACES WHICH ARE TO RECEIVE A FINISH APPLICATION SHALL BE COMPLETELY SMOOTH AS SUITABLE FOR SCHEDULED FINISH MATERIAL. REPAIR EXISTING CONDITIONS AS REQUIRED.

7. ALL PAINT SURFACES ARE TO RECEIVE ONE PRIME COAT AND A MINIMUM OF TWO FINISH COATS. APPLY ADDITIONAL COATS OF PRIME AND FINISH PAINT AS REQUIRED UNTIL EXISTING UNDERCOATS OR OTHER CONDITIONS ARE FULLY CONCEALED AND PAINT FILM IS OF UNIFORM FINISH, COLOR AND APPEARANCE. PREP, PRIME AND PAINT UP TO 6'-0" A.F.F WITH TWO-PART EPOXY THROUGHOUT, UNO. PAINT FROM 6'-0" TO 10'-0" A.F.F WITH ONE-PART EPOXY, UNO.

8. USE FLOORING MANUFACTURER'S RECOMMENDED ADHESIVE, U.N.O.

9. FLOORING TRANSITIONS WILL OCCUR UNDER CENTERLINE OF DOOR IN CLOSED POSITION, U.N.O.

10. WHERE FLOORING MATERIALS OF DIFFERING THICKNESSES MEET (IE TILE TO WOOD), LEVEL AS REQUIRED TO MEET ADA GUIDELINES AND ENSURE SMOOTH TRANSITION. COORDINATE TRANSITION DETAILS AFTER DEMOLITION OCCURS.

12. INSTALL SELF-LEVELING COMPOUND TO LEVEL FLOOR TO TCNA REQUIREMENTS AS REQUIRED.

11. PRIOR TO FLOORING INSTALLATIONS, PERFORM SLAB TESTS TO ENSURE MOISTURE CONTENT MEETS MANUFACTURER'S ACCEPTABLE LEVELS. CONTRACTOR TO DOCUMENT AND MAINTAIN RECORDS. G.C. TO TAKE APPROPRIATE MEASURES TO ENSURE WATER VAPOR FROM THE SUBFLOOR DOES NOT AFFECT THE LONG TERM INSTALLATION OF THE FLOORING FINISHES.

12. GC SHALL VERIFY EXISTING PAINT TYPE (OIL VS. LATEX) AND SHALL USE APPROPRIATE PRIMER ACCORDINGLY.

13. PAINT FINISHES: TRIM/MOULDING/MILLWORK/DOORS= SEMI-GLOSS, CEILINGS & WALLS = EGGSHELL.

FINISH LEGEND



NOT IN SCOPE FOR WALL PAINTING ONLY. HOLLOW METAL FRAMES SHOULD STILL BE REPAINTED.




CPT-1



GuernseyTingle
757-220-0220 Williamsburg, VA

ICC BERKELEY MIDDLE HOOL FINISHES

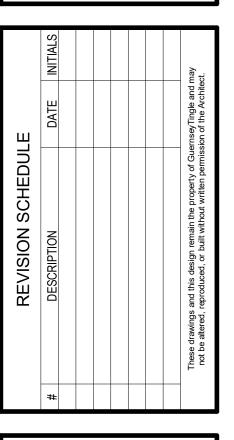

FINISH SCHEDULE

STEPHANIE L.
KALANTARIANS
Lic. No. 013629

Date: 3/1/2024

Drawn: TOG Checked: SLK

Project: 223133

I-101

otted on: 3/7/2024 2:13:45 PM